NEW CONSTRUCTION:

11 PARKER STREET

DEVELOPER
POLAR VIEWS
89 WEST MAIN STREET, UNIT 101
NORTHBOROUGH, MA 01532
MR DANIEL YARNIE

CIVIL ENGINEER

J.M. GRENIER ASSOCIATES, INC.


118 TURNPIKE ROAD, SUITE 200

SOUTHBOROUGH, MA 01752

(T) 508.845.2500

ARCHITECT
DIXON SALO ARCHITECTS, INC.
300 MAIN STREET, FIRST FLOOR
WORCESTER, MA 01608
MR. JESSE HILGENBERG
(T) 508.755.0533
JHILGENBERG@DIXONSALOARCHITECTS.COM

LEGEND **ABBREVIATIONS** SYMBOLS **MATERIALS** DRAWING SYMBOLS ABOVE FINISHED FLOOR MASONRY OPENING AVCHILECT AVERAGE BEAM BOARD BRASS BRONZE BUILDING BUILT-IN CABINET CEILING CENTER LINE CENTIMETER SECTION EARTH - LOAM EXIST WALL TO REMAIN MECHANICAL _ _ _ _ DEMO EXIST WALL CERAMIC CLEAR COLD WATER EMERGENCY EXIT SIGN COLUMN CONCRETE OPPOSITE PAINTED PARTITION **EXTERIOR** CONCRETE HORN/STROBE CONCRETE MASONRY UNIT CONSTRUCTION CONTINUOUS CONTRACTOR **ELEVATION** CONCRETE MASONRY PLUMBING PLYWOOD PRESSURE TREATED DEMOLITION EMERGENCY BATTERY UNIT ELEVATION DIMENSION DOOR DOWN REMOTE HEAD EMERGENCY EXIT SIGN W/BATTERY UNIT BITUMINOUS CONCRETE DRAWING DRINKING FOUNTAIN INDICATION EACH ELECTRIC ELECTRIC WATER COOLER FIRE EXTINGUISHER **BATT INSULATION** WINDOW CARD READER ACCESS INDICATION ROUGH OPENING SCHEDULE SECTION SHEET SIMILAR SOLID CORE RIGID INSULATION PARTITION FABRICATE FEET TYPE WOOD - FRAMING FINISH FINISHED ALL OVER FIREPROOF FLOOR SMOKE DETECTOR ROOM 123 SQUARE INCHES WOOD - FINISH NUMBER STAINLESS STEEL FLUORESCEN FLOURESCENT LIGHTING FIXTURE PLYWOOD - SMALL SCALE (A | 9'-0" GENERAL GLASS GYPSUM BOARD SPRINKLER HEAD TEMPERATURE TONGUE & GROOVE ACOUSTICAL TILE HARDWARE HVAC GRILLE - RETURN HEIGHT HOLLOW CORE HORIZONTAL HOT WATER **HVAC - SUPPLY VENT THROUGH ROOF** INCH INSULATION VERIFY IN THE FIELD INTERIOR JUNCTION BOX LAVATORY LIGHT

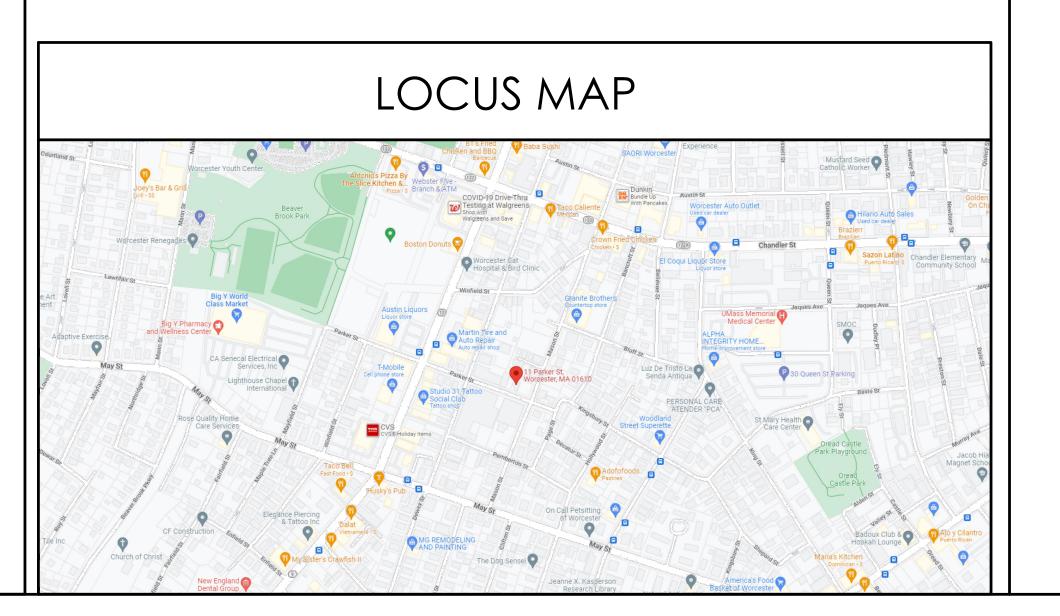

LIST OF DRAWINGS

T-1.1 T-1.2 GENERAL NOTES & DETAILS GROUND FLOOR PLAN
FIRST FLOOR - FLOOR PLAN
SECOND FLOOR - FLOOR PLAN THIRD FLOOR - FLOOR PLAN ROOF PLAN GROUND FLOOR - REFLECTED CEILING PLAN FIRST FLOOR - REFLECTED CEILING PLAN SECOND FLOOR - REFLECTED CEILING PLAN THIRD FLOOR - REFLECTED CEILING PLAN FIRST FLOOR - FINISH PLAN SECOND FLOOR - FINISH PLAN THIRD FLOOR - FINISH PLAN BUILDING ELEVATIONS BUILDING ELEVATIONS BUILDING ELEVATIONS BUILDING ELEVATIONS **BUILDING SECTION BUILDING SECTION** ENLARGED UNIT PLANS & ELEVATIONS - TYPE 1 ENLARGED UNIT PLANS & ELEVATIONS - TYPE 2 INTERIOR ELEVATIONS & TYPICAL DETAILS TYPICAL RAMP DETAILS DOOR SCHEDULE, WINDOW SCHEDULE & ROOM FINISH SCHEDULE



ARCHITECT'S STAMP:

ENGINEER:

ENGINEER'S STAMP:

GENERAL INFORMATION:

SCHEMATIC 12.20.2022
DESIGN DEVELOPMENT 12.08.2023
BID
PERMIT
CONSTRUCTION
EXISTING CONDITIONS

4
3
2
1
REVISION DATE

DATE: 02.05.2024

SCALE: AS NOTED

PROJECT: -
DRAWN: JGH

CHECKED: JGH

PROJECT TITLE:

RESIDENTIAL BUILDING

11 PARKER

11 PARKER WORCESTER, MA 01610

TITLE SHEET

SHEET NUMBER:

T-1.0

GENERAL DEMOLITION NOTES

A. CONTRACTOR SHALL VISUALLY INSPECT THE SITE TO DETERMINE THE CONDITION OF EXISTING CONSTRUCTION AND FAMILIARIZE HIMSELF/HERSELF WITH THE PROPOSED WORK.

- 1. ALL WORK SHALL COMPLY WITH MUNICIPAL, STATE AND FEDERAL RULES AND REGULATIONS, LAWS AND ORDINANCES OF ALL THE AUTHORITIES HAVING JURISDICTION.
- 2. DISCONNECTION OF UTILITIES REQUIRED BY THE WORK SHALL BE PERFORMED BY QUALIFIED
- ALL WORK IS TO COMPLY WITH APPLICABLE PROVISIONS OF ANSI CODE FOR BUILDING CONSTRUCTION; ANS 1 10.6, SAFETY OF DEMOLITION.
- 4. UTILITY LINES TO BE ABANDONED SHALL BE DISCONNECTED. REMOVE AS REQUIRED, AND/OR CAPPED OFF IN ACCORDANCE WITH APPLICABLE CODE AND REGULATIONS.
- 5. REMOVE ALL AREAS SHOWN DASHED (TYPICAL) ON DEMOLITION PLANS.
- CONTRACTOR TO PROTECT ALL EXISTING AREAS BEYOND LIMIT OF WORK OR ITEMS THAT ARE TO REMAIN, AS REQUIRED.
- 7. COORDINATE DEMOLITION WORK WITH PROPOSED NEW WORK SHOWN ON PROJECT DRAWINGS.
- 8. THE GENERAL CONTRACTOR SHALL NOT INTERFERE WITH NORMAL ACTIVITY IN OR ADJACENT TO THE BUILDING, AND IS SHALL TAKE ALL NECESSARY SAFETY PRECAUTIONS TO PREVENT EXCESSIVE DUST, AND NOISE, ACCESS AND EGRESS TO AND FROM THE EXISTING BUILDING AS WELL AS FIRE PROTECTION IS TO BE MAINTAINED AT ALL TIMES THROUGHOUT THE ENTIRE CONSTRUCTION PROCESS.
- PROVIDE ALL TEMPORARY SHORING BRACING, FRAMING, AND PROTECTION OF EXISTING WORK TO REMAIN BEFORE PROCEEDING WITH DEMOLITION AND DURING ALTERATION WORK.
- 10. PERFORM DEMOLITION WORK AS REQUIRED TO ACCOMMODATE NEW CONSTRUCTION. CONTRACTOR SHALL VERIFY THAT ALL REMOVED COMPONENTS ARE NOT STRUCTURAL, NOTIFY ARCHITECT BEFORE REMOVING ANY STRUCTURAL MEMBERS. NOTIFY ARCHITECT IN CASE OF DISCREPANCY BEFORE PROCEEDING WITH WORK.
- 11. IF DURING DEMOLITION CONDITIONS ARE REVEALED THAT MAY JEOPARDIZE THE INTEGRITY OF THE STRUCTURE OR PRECLUDE THE DESIGN INTENT, THE GENERAL CONTRACTOR SHALL NOTIFY THE ARCHITECT IMMEDIATELY.
- 12. DEMOLITION PLANS ASSUME THAT PORTIONS OF EXISTING WIRING, PLUMBING, EQUIPMENT, DUCTWORK, ETC., IN AREAS OF NEW WORK WILL BE REQUIRED TO BE REMOVED/RELOCATED TO MEET THE REQUIRED DESIGN PARAMETERS OF THE NEW WORK, PRIOR TO COMMENCING DEMOLITION/RELOCATION, CONTRACTOR SHALL VERIFY SPECIFIC CONDITIONS IN THE FIELD AND COORDINATE WITH GC AND ARCHITECT. (SEE M.E.P. DEMOLITION NOTES.)
- 13. BEFORE DISPOSING OF ANY REMOVED ITEMS, CONSULT WITH OWNER AND VERIFY POSSIBLE RE-USE, SALVAGE. OR DISPOSAL OF ANY EXISTING ITEMS AND EQUIPMENT, INCLUDING BUT NOT LIMITED TO, PLUMBING, FIXTURES, EQUIPMENT, LIGHT FIXTURES AND DOORS, ETC.

B. CUTTING AND PATCHING

- 14. GENERAL CONTRACTOR IS RESPONSIBLE FOR COORDINATION OF ALL SUBCONTRACTORS, DEMOLITION CUTTING AND PATCHING
- 15. ALL PARTITIONS, FLOORS, CEILINGS OR ITEMS TO BE REMOVED SHALL BE CLEANLY CUT BACK TO THE LIMITS SHOWN ON THE PLANS, SECTIONS, AND DETAILS OR AS DIRECTED BY THE ARCHITECT.
- 16. ALL EXISTING FLOORS, WALLS, AND CEILINGS AFFECTED BY NEW WALL LOCATIONS ARE TO BE PATCHED AND REPAIRED AS NECESSARY TO PROVIDE A SMOOTH UN-NOTICEABLE TRANSITION OF NEW AND EXISTING MATERIALS AND SURFACES.
- 17. PROVIDE CUTTING AND PATCHING AS REQUIRED FOR ALL DEMOLITION AND ALTERATION WORK. CUTTING AND PATCHING INCLUDE CUTTING INTO OR THROUGH TO PROVIDE FOR THE INSTALLATION OR PERFORMANCE OF OTHER WORK, AND THE SUBSEQUENT FITTING AND PATCHING REQUIRED TO RESTORE THE CUT SURFACES TO THEIR ORIGINAL CONDITION.
- REMOVE EXISTING INTERIOR FINISHES AND MATERIALS AS REQUIRED TO ACCOMMODATE NEW WORK. ALL ITEMS ARE TO BE REMOVED IN A MANNER SO AS TO NOT DAMAGE THE EXISTING MATERIALS OR FINISHES THAT ARE TO REMAIN OR BE REINSTALLED.
- 20. PERFORM DEMOLITION WORK CAREFULLY. REMOVE MASONRY, STEEL, CONCRETE, WALLS AND OTHER STRUCTURAL ELEMENTS IN SMALL SECTIONS. REMOVE THESE MATERIALS TO A CLEANLY CUT, STRAIGHT LINE, ACCURATELY ESTABLISHED.
- 21. REMOVE FROM THE SITE AND DISPOSE OF LEGALLY, ALL EXISTING MATERIALS, DEMOLITION DEBRIS, TRASH, RUBBISH AND ITEMS THAT WILL NOT BE USED IN THE NEW WORK OR WILL NOT BE REUSED BY THE OWNER. STORAGE OF DEBRIS WILL NOT BE PERMITTED. ALL DEBRIS TO BE REMOVED AND DISPOSED OF IN ACCORDANCE WITH STATE AND LOCAL REGULATIONS.
- 22. COORDINATE REMOVAL OF ANY RATED ASSEMBLIES WITH LOCAL OFFICIALS BEFORE COMMENCING

C. M.E.P. DEMOLITION NOTES

- 23. SEE ELECTRICAL, HVAC, PLUMBING AND FIRE PROTECTION DRAWINGS FOR LOCATION OF NEW UTILITIES AND DEMOLITION OF EXISTING WORK NOT SHOWN ON THESE PLANS. GC TO COORDINATE ALL WORK WITH SUBCONTRACTORS.
- 24. WHERE EXISTING ELECTRICAL DEVICES OCCUR IN PARTITIONS INDICATED TO BE REMOVED, THE WIRING SHALL BE REMOVED, ALL ELECTRICAL LINES BEING DISCONNECTED SHALL BE ADEQUATELY TRACED AND RECONNECTED AS REQUIRED TO ENSURE PROPER FUNCTION FOR THE ADJACENT AREAS AND TO ENSURE PROPER FUNCTION OF THE EXISTING BUILDING EQUIPMENT OR SYSTEM TO REMAIN, ELECTRICAL CONTRACTOR TO VERIFY ALL ELECTRICAL SYSTEMS PRIOR TO THE COMMENCEMENT OF WORK.
- 25. WHERE EXISTING PLUMBING LINES ARE TO BE REWORKED OR REMOVED, ALL PLUMBING LINES BEING DISCONNECTED SHALL BE ADEQUATELY TRACED AND RECONNECTED AS REQUIRED TO ENSURE PROPER FUNCTION FOR THE ADJACENT AREAS AND TO ENSURE PROPER FUNCTION OF THE EXISTING BUILDING EQUIPMENT TO REMAIN IN PLACE.
- WHERE EXISTING HVAC LINES, DUCTWORK, ETC. ARE TO BE REWORKED, ALL LINES AND EQUIPMENT BEING DISCONNECTED SHOULD BE ADEQUATELY TRACED AND RECONNECTED AS REQUIRED TO ENSURE PROPER FUNCTION FOR THE ADJACENT AREAS AND TO ENSURE PROPER FUNCTION TO THE EXISTING BUILDING EQUIPMENT OR SYSTEMS TO REMAIN.
- 27. COORDINATE WITH MECHANICAL AND ELECTRICAL DRAWINGS FOR LOCATIONS OF ALL NEW PENETRATIONS THRU ROOF, FLOORS, WALLS, AND CEILINGS.

D. CLEANING


28. CONTRACTOR IS FULLY RESPONSIBLE FOR THE CLEANING AND PREPARING OF ALL FLOOR, WALL AND CEILING SURFACES FOR THE INSTALLATION OF NEW MATERIALS AS SCHEDULED, UTILITIES, HVAC AND ELECT. SYSTEMS EQUIPMENT, ETC. AFTER DEMO CLEAN-UP.

OTHER: REMINDERS/SPECIFIC TO INDIVIDUAL PROJECTS

- 29. EXISTING LARGE FLOOR OPENINGS TO BE FILLED ARE INDICATED, SMALLER PIPE HOLES, ETC. TO BE FILLED ARE NOT INDICATED ON THE DRAWINGS. REFER TO DETAILS FOR REQUIREMENTS FOR FILLING SAID OPENINGS.
- 30. ALL EXISTING COLUMNS TO REMAIN UNLESS NOTED.
- 31. ALL EXPOSED UNUSED PIPING AND CONDUITS SHALL BE REMOVED BY THE GENERAL CONTRACTOR. SEE SPECIFICATIONS FOR CAPPING.

GENERAL CONSTRUCTION NOTES

- 1. ALL WORK IS TO BE PERFORMED IN PROFESSIONAL AND WORKMANLIKE MANNER, IN ACCORDANCE WITH ALL APPLICABLE FEDERAL & STATE CODES, INCLUDING THE INTERNATIONAL BUILDING CODE (IBC). THESE INCLUDE, BUT ARE NOT LIMITED TO, THE INTERNATIONAL EXISTING BUILDING CODE (IEBC), MASS STATE BUILDING CODE, THE AMERICAN NATIONAL STANDARD (ANSI), THE INTERNATIONAL ENERGY CONSERVATION CODE (IECC), THE NATIONAL ELECTRIC CODE (NEC), THE INTERNATIONAL PLUMBING CODE (IPC), THE INTERNATIONAL MECHANICAL CODE (IMC), AND THE NATIONAL FIRE PROTECTION STANDARDS, AS WELL AS ALL LOCAL REGULATIONS GOVERING THE PROJECT.
- 2. CONTRACTOR TO VISIT SITE AND TO VERIFY ALL DIMENSIONS AND CONDITIONS IN THE FIELD, AND REPORT ALL DISCREPANCIES TO ARCHITECT, PRIOR TO PROCEEDING WITH WORK.
- 3. ALL MATERIALS USED ON THIS PROJECT SHALL BE IN COMPLIANCE WITH THE APPLICABLE INTERNATIONAL BUILDING CODE.
- 4. THE CONTRACTOR SHALL MAINTAIN COMPLETE AND UP-TO-DATE DRAWINGS AT THE JOB SITE, AND SHALL SUBMIT ACCURATE AS-BUILT DRAWINGS TO ARCHITECT AND OWNER AT END OF PROJECT.
- 5. THE INTENTION OF THE CONTRACT DOCUMENTS IS TO INCLUDE ALL LABOR, MATERIALS, EQUIPMENT AND OTHER ITEMS NECESSARY FOR THE PROPER EXECUTION AND COMPLETION OF THE WORK.
- 6. BY EXECUTING THE CONTRACT, THE CONTRACTOR REPRESENTS THAT THEY HAVE VISITED THE SITE AND HAVE FAMILIARIZED THEM SELF WITH THE CONDITIONS UNDER WHICH THE WORK IS TO BE PERFORMED.
- 7. THE ARCHITECT WILL HAVE AUTHORITY TO REJECT WORK WHICH DOES NOT CONFORM TO THE CONTRACT DOCUMENTS.
- 8. THE CONTRACTOR SHALL SUPERVISE AND DIRECT THE WORK, USING THEIR BEST SKILLS AND ATTENTION. THE CONTRACTOR SHALL BE SOLELY RESPONSIBLE FOR ALL CONSTRUCTION MEANS, METHODS, TECHNIQUES, SEQUENCES, PROCEDURES, & SHORING, AND FOR COORDINATING THE WORK OF ALL SUB-CONTRACTORS.
- 9. EACH CONTRACTOR SHALL PERFORM ALL REQUIRED CUTTING AND PATCHING FOR THEIR OWN TRADE, UNLESS OTHERWISE NOTED.
- 10. DRAWINGS SHALL NOT BE SCALED TO OBTAIN DIMENSIONS.
- 11. CONTRACTOR SHALL PROPERLY PROTECT AND MAKE SAFE WORK PREMISES.
- 12. THE CONTRACTOR SHALL KEEP THE WORKSITE CLEAN AND TIDY, AND AT ALL TIMES SHALL KEEP THE PREMISES FREE FROM ACCUMULATION OF WASTE MATERIALS OR TRASH CAUSED BY THEIR OPERATIONS.
- 13. ALL EXITS SHALL BE KEPT READILY ACCESSIBLE AND UNOBSTRUCTED AT ALL TIMES AND SHALL MAINTAIN REQUIRED EMERGENCY EGRESS DURING CONSTRUCTION.
- 14. THE CONTRACTOR SHALL INDEMNIFY AND HOLD HARMLESS THE OWNER AND THE ARCHITECT, AND THEIR AGENTS AND EMPLOYEES, FROM AND AGAINST ANY CLAIMS, DAMAGES, LOSSES AND EXPENSES INCLUDING ATTORNEY'S FEES ARISING OUT OF OR RESULTING FROM THE PERFORMANCES OF THE WORK.
- 15. THE CONTRACTOR SHALL PAY ALL FEES AND SECURE PERMITS FROM ALL AGENCIES HAVING JURISDICTION AND AT COMPLETION SHALL SEE THAT THE PROJECT IS SIGNED OFF BY THE APPROPRIATE AUTHORITY HAVING JURISDICTION.
- 16. WEATHER PROTECTION: THE CONTRACTOR SHALL AT ALL TIMES PROVIDE PROTECTION AGAINST THE RAIN, WIND, STORM, FROST, OR HEAT SO AS TO MAINTAIN ALL WORK MATERIALS, APPARATUS, AND FIXTURES FROM INJURY OR DAMAGE.
- 17. THE CONTRACTOR SHALL PROTECT ALL AREAS OUTSIDE THE CONTRACT LIMITS AND RESTORE ALL SUCH PROPERTY TO ITS CONDITION PRIOR TO THE START OF THE WORK.
- 18. DAMAGE: ALL WORK DAMAGED BY FAILURE TO PROVIDE PROTECTION SHALL BE REMOVED AND REPLACED WITH NEW WORK AT THE CONTRACTORS EXPENSE. THE CONTRACTOR SHALL UNCONDITIONALLY GUARANTEE ALL MATERIALS AND WORKMANSHIP UNTIL THE DATE OF OWNER'S ACCEPTANCE AND SHALL REPLACE ANY DEFECTIVE WORK WITHIN THAT PERIOD WITHOUT EXPENSES TO THE OWNER AND PAY FOR ALL DAMAGES TO OTHER PARTS OF THE BUILDING CAUSED BY REPAIR OF THEIR WORK.
- 19. ALL FINISHES SHALL COMPLY WITH THE LIMITS FOR FIRE RESISTANCE/FLAMMABILITY AS SPECIFIED IN THE APPLICABLE INTERNATIONAL BUILDING CODE.
- 20. ALL DEMOLITION AND RELOCATING OF EXISTING MEP SYSTEMS EFFECTING NEW PLUMBING, HVAC, AND ELECTRICAL SYSTEMS SHALL BE COORDINATED WITH RESPECTIVE SUBCONTRACTORS. RELOCATE/REWORK ALL ACTIVE MECHANICAL AND ELECTRICAL LINES WHERE REQUIRED DUE TO REMOVALS AND NEW LAYOUT. MODIFICATIONS FROM THE DRAWINGS SHALL BE BROUGHT TO THE ATTENTION OF THE ARCHITECT BEFORE COMMENCING WORK.
- 21. CONTRACTORS SHALL COORDINATE WITH PROPERTY MANAGER AS REQUIRED WHEN ITEMS OF NEW PLUMBING WORK REQUIRE ACCESS TO ADJACENT COMMON AREAS, AND TENANT SPACES OUTSIDE AREA OF WORK REPLACE AND RESTORE FINISHES TO MATCH AFTER COMPLETION OF WORK.
- 22. PROVIDE ALL BLOCKING REQUIRED TO INSTALL MILLWORK, EQUIPMENT, CASEWORK, GRAB BARS, RAILINGS, ETC. TYPE AND LOCATION SHALL BE SUBJECT TO REVIEW BY ARCHITECT.
- 23. FOAM IN PLACE INSULATION FOR SMALL GAPS AND VOIDS.
- 24. CAULK ALL JOINTS OF DISSIMILAR MATERIALS.
- 25. PLAN DIMENSIONS ARE TO FACE OF PARTITION AT INTERIOR AND FACE OF FOUNDATION AT EXTERIOR, UNLESS OTHERWISE NOTED.
- 26. REFER TO OWNERS ENVIRONMENTAL REPORT REGARDING CONTAMINANTS AND ASBESTOS ON THE PROJECT SITE/BUILDING.

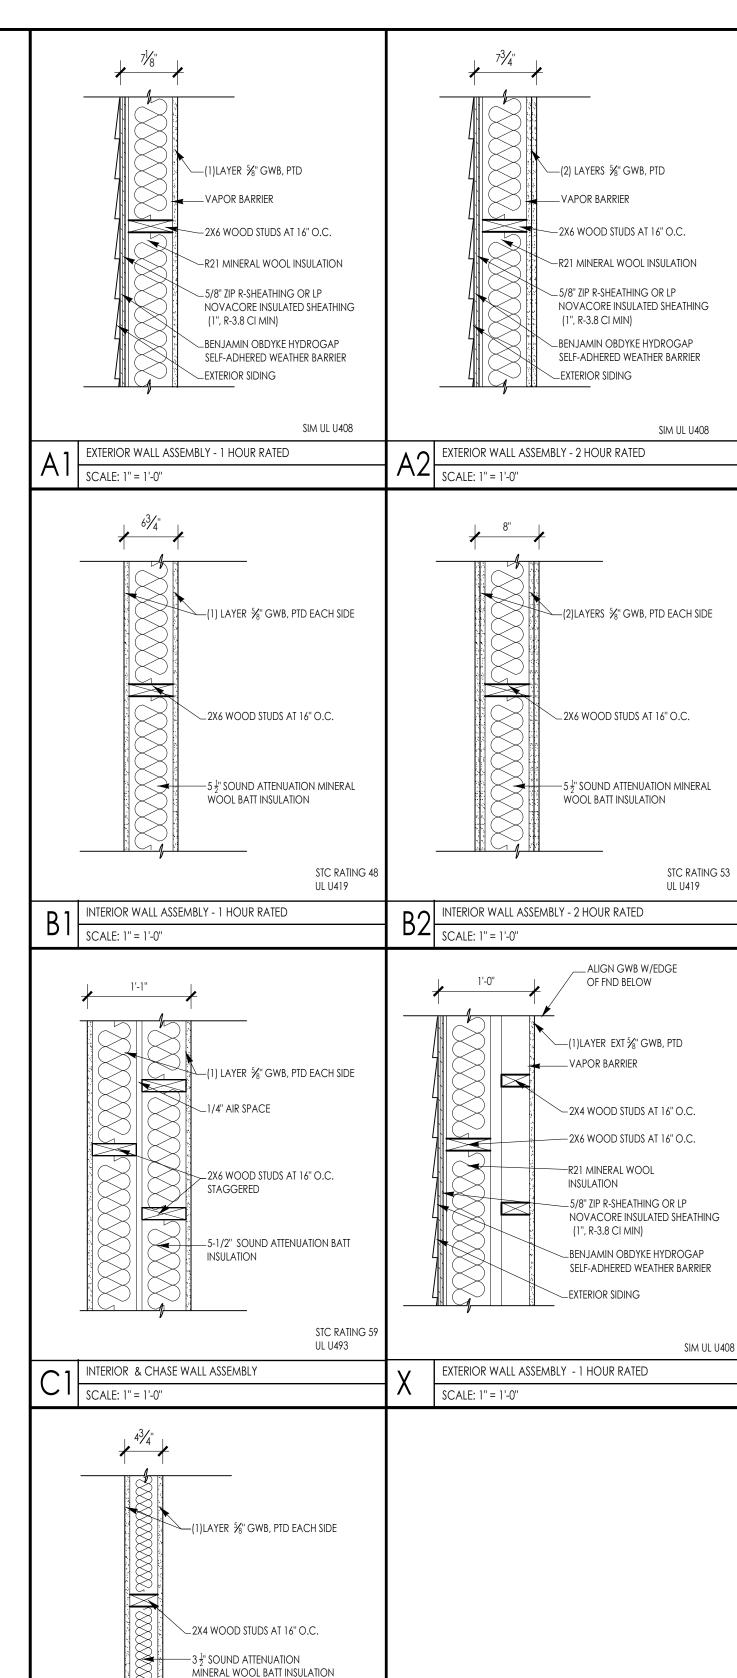


PROVIDE ACOUSTICAL SEALANT @ ALL

BATHROOM AND BEDROOM WALLS

INTERIOR WALL

SCALE: 1" = 1'-0"

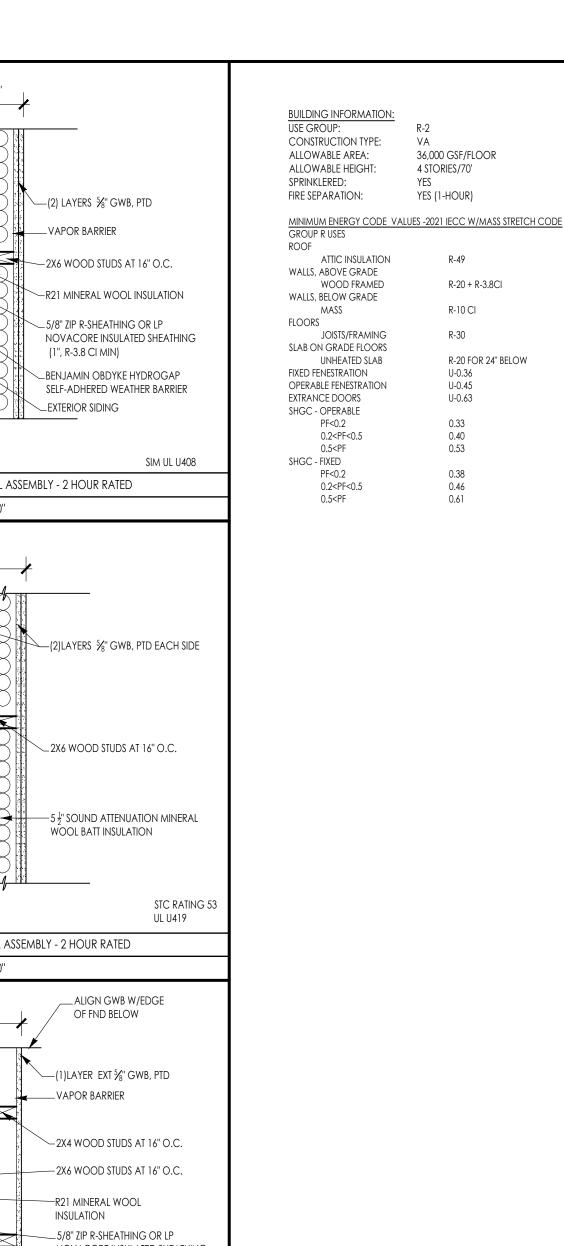



ENGINEER:

GENERAL INFORMATION:

ENGINEER'S STAMP:

SCHEMATIC 12.20.2022 DESIGN DEVELOPMENT 12.08.2023 BID PERMIT CONSTRUCTION ☐ EXISTING CONDITIONS

REVISION DATE 02.05.2024 AS NOTED PROJECT: - -JGH

JGH

PROJECT TITLE: RESIDENTIAL BUILDING 11 PARKER WORCESTER, MA 01610


DRAWN:


CHECKED:


SHEET TITLE: GENERAL NOTES & DETAILS


SHEET NUMBER:


2/23/2024 6:59 PM

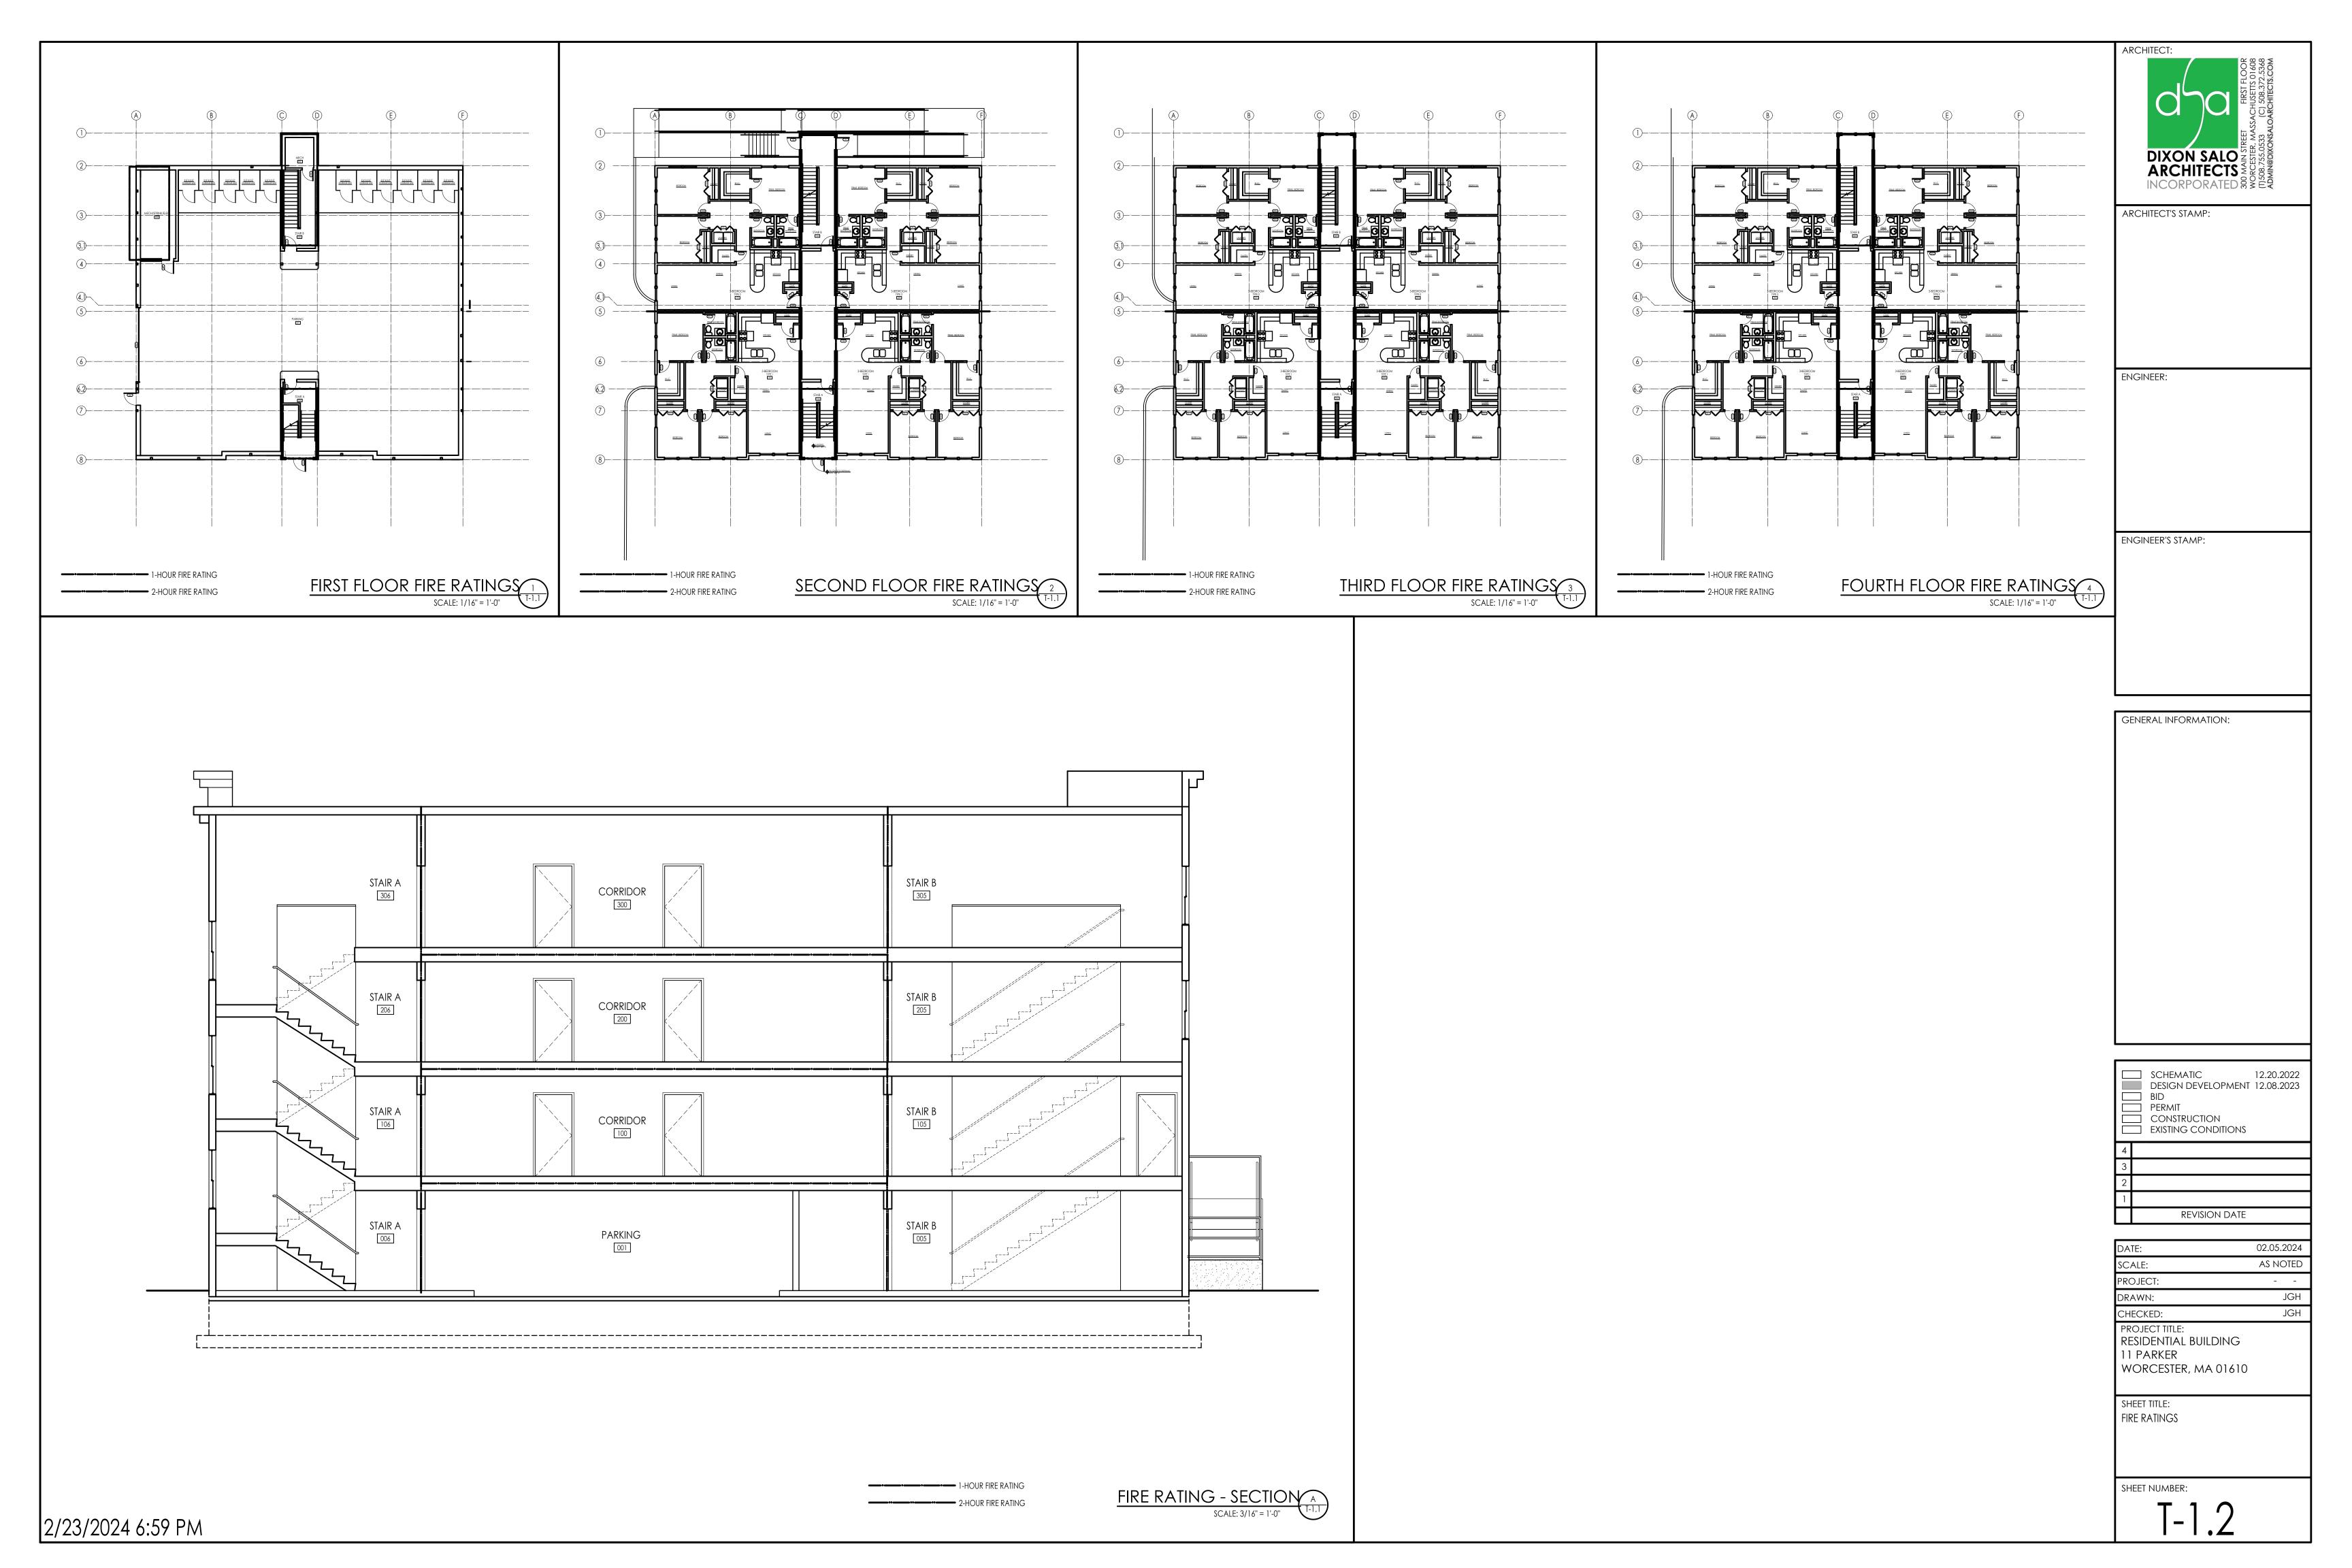


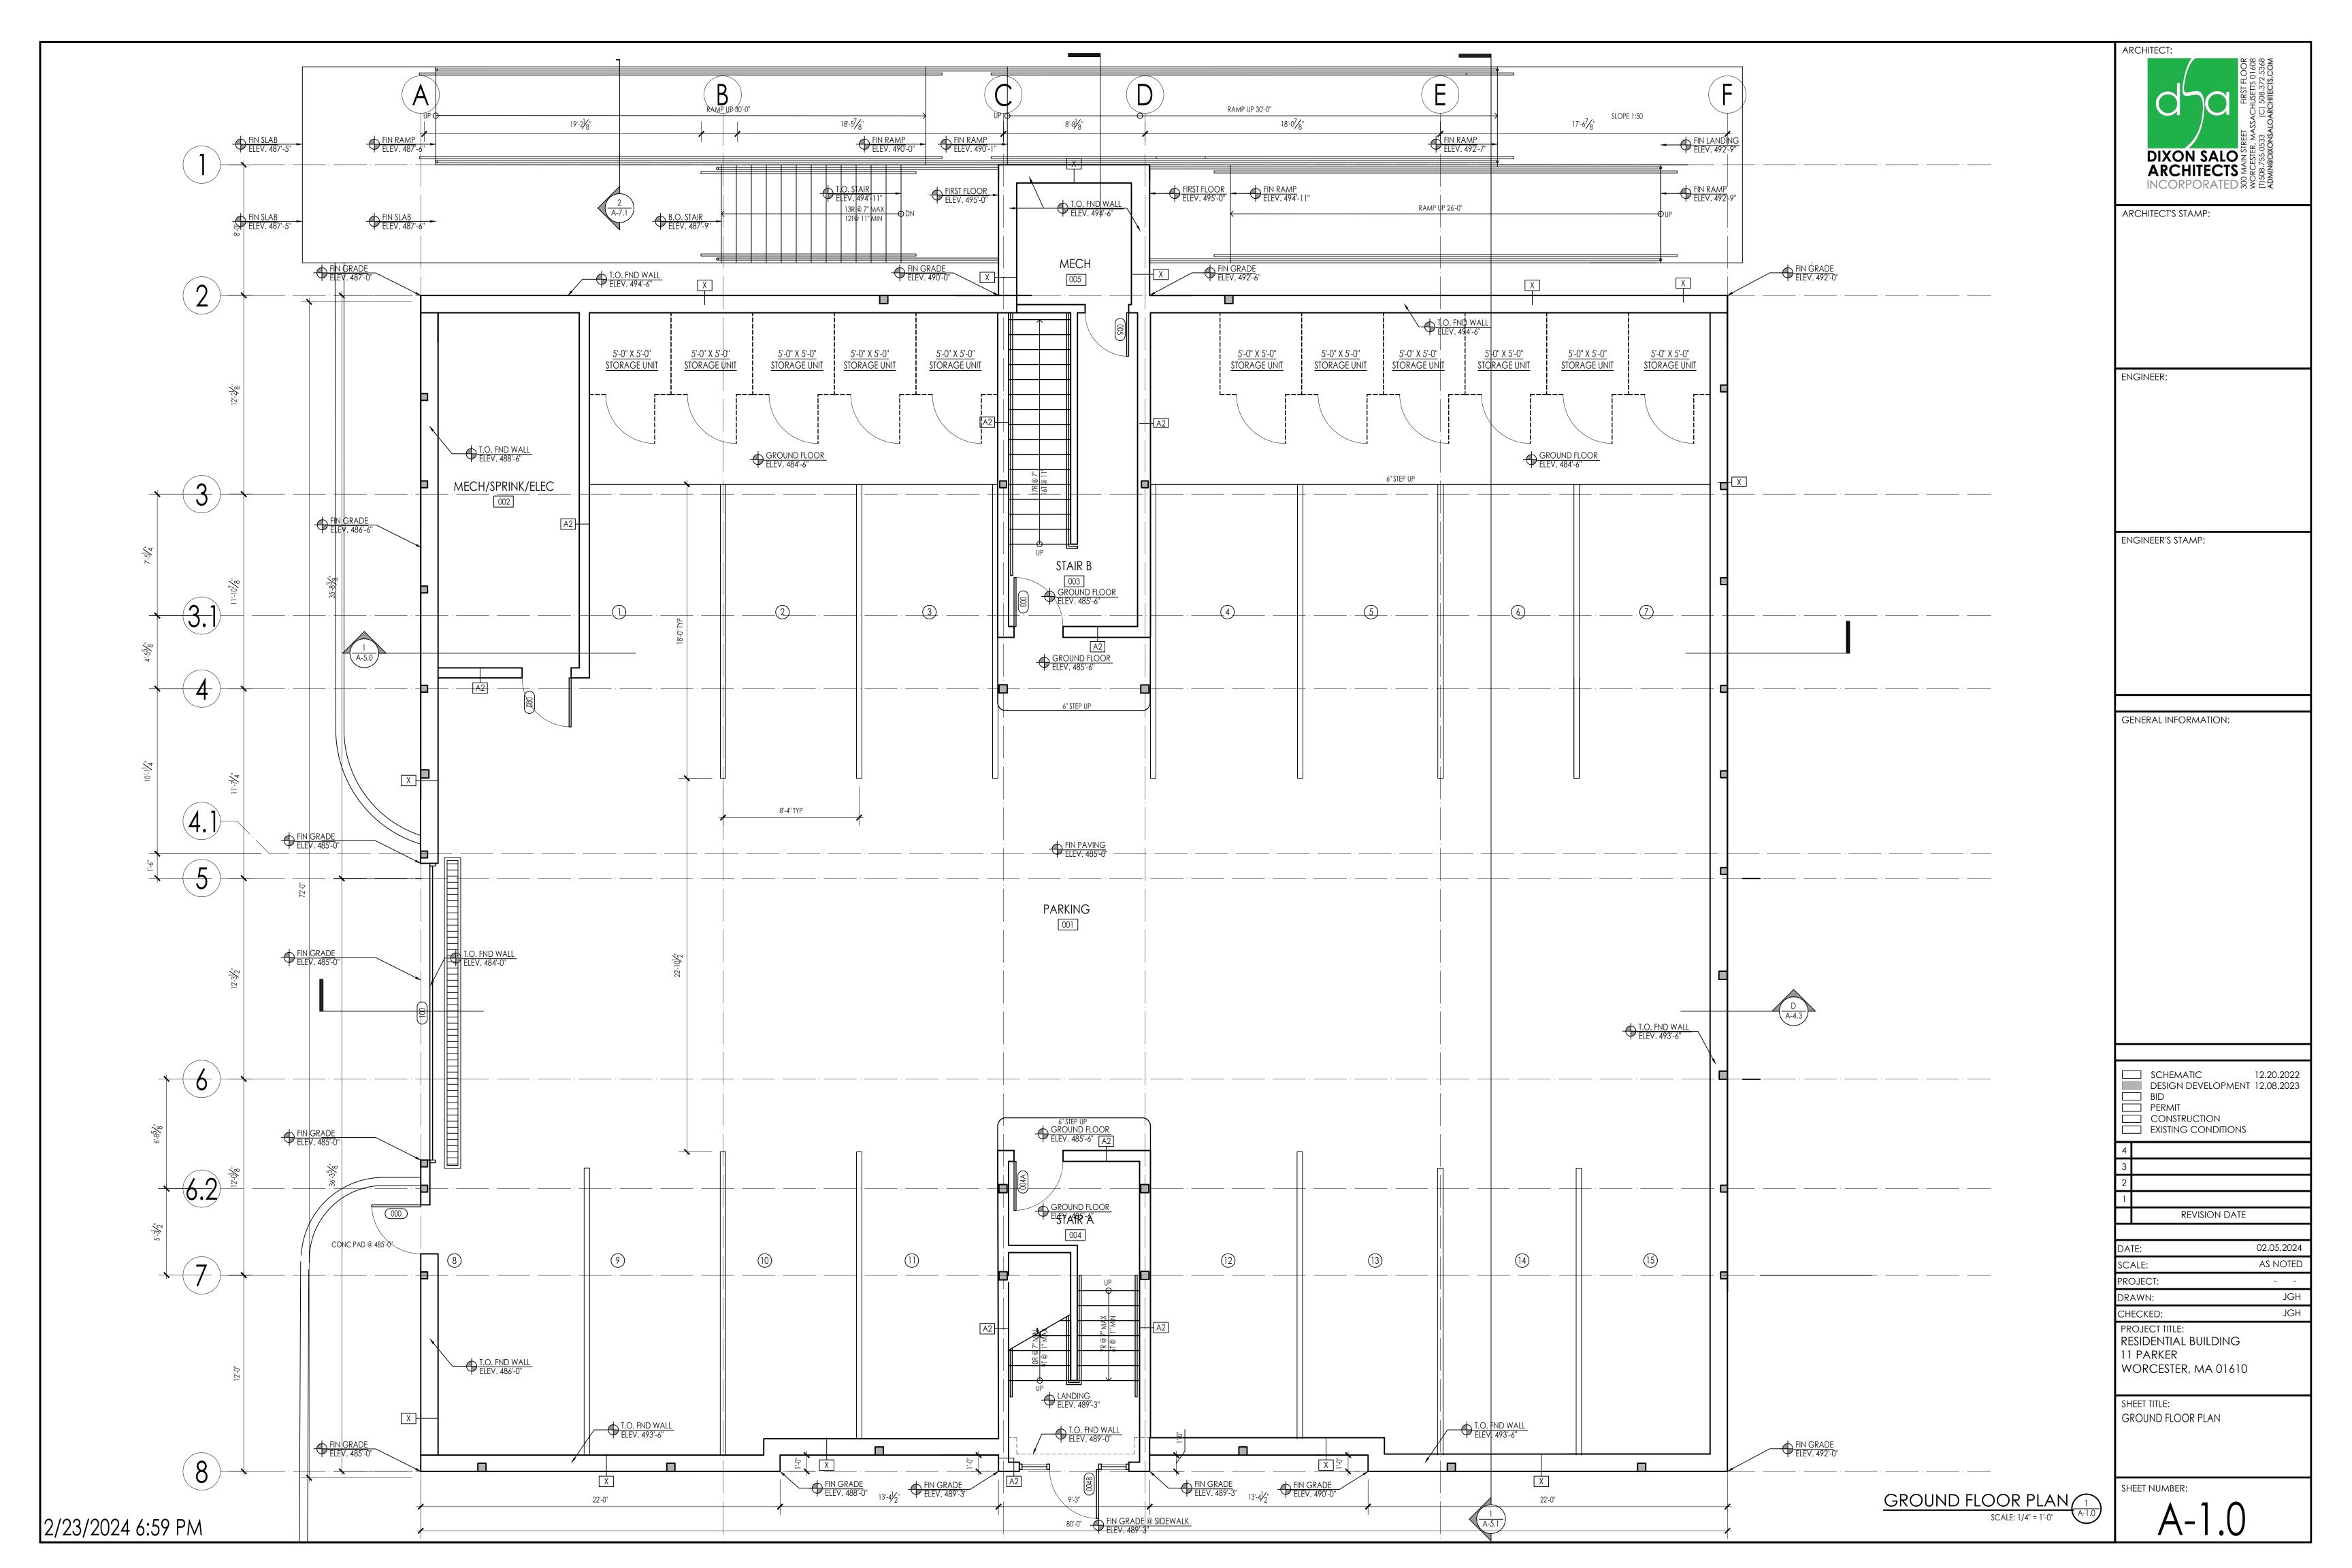


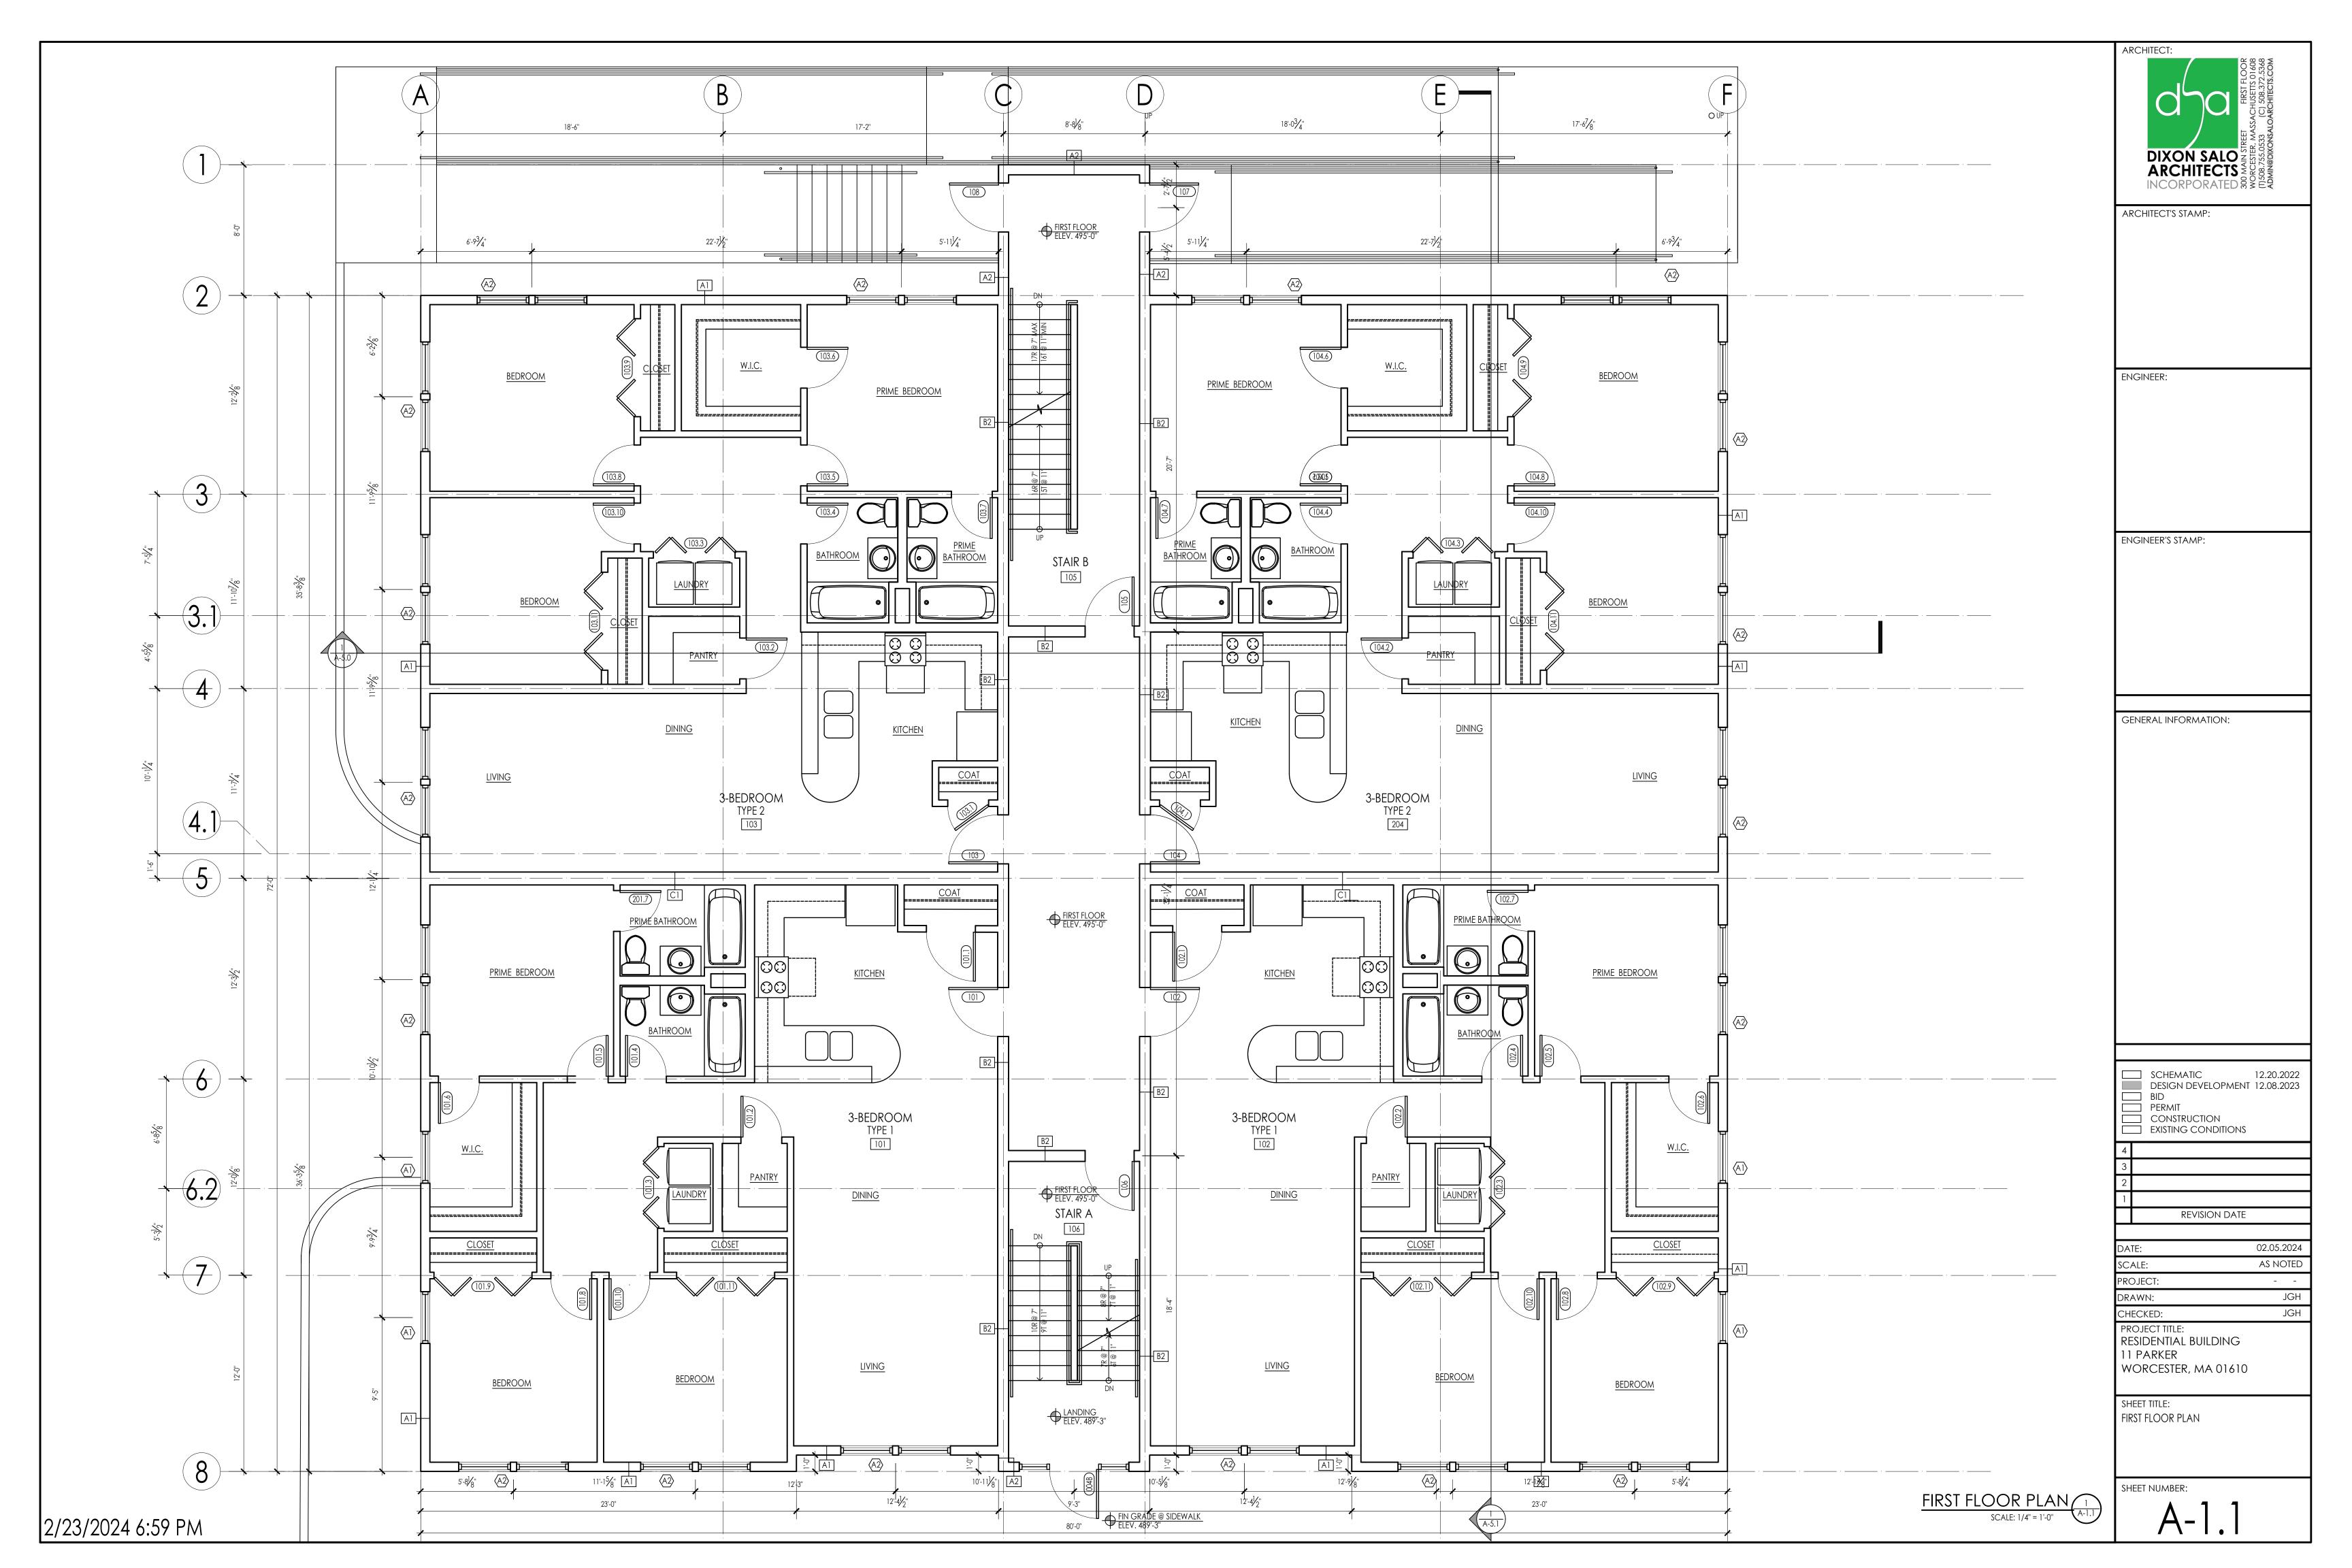


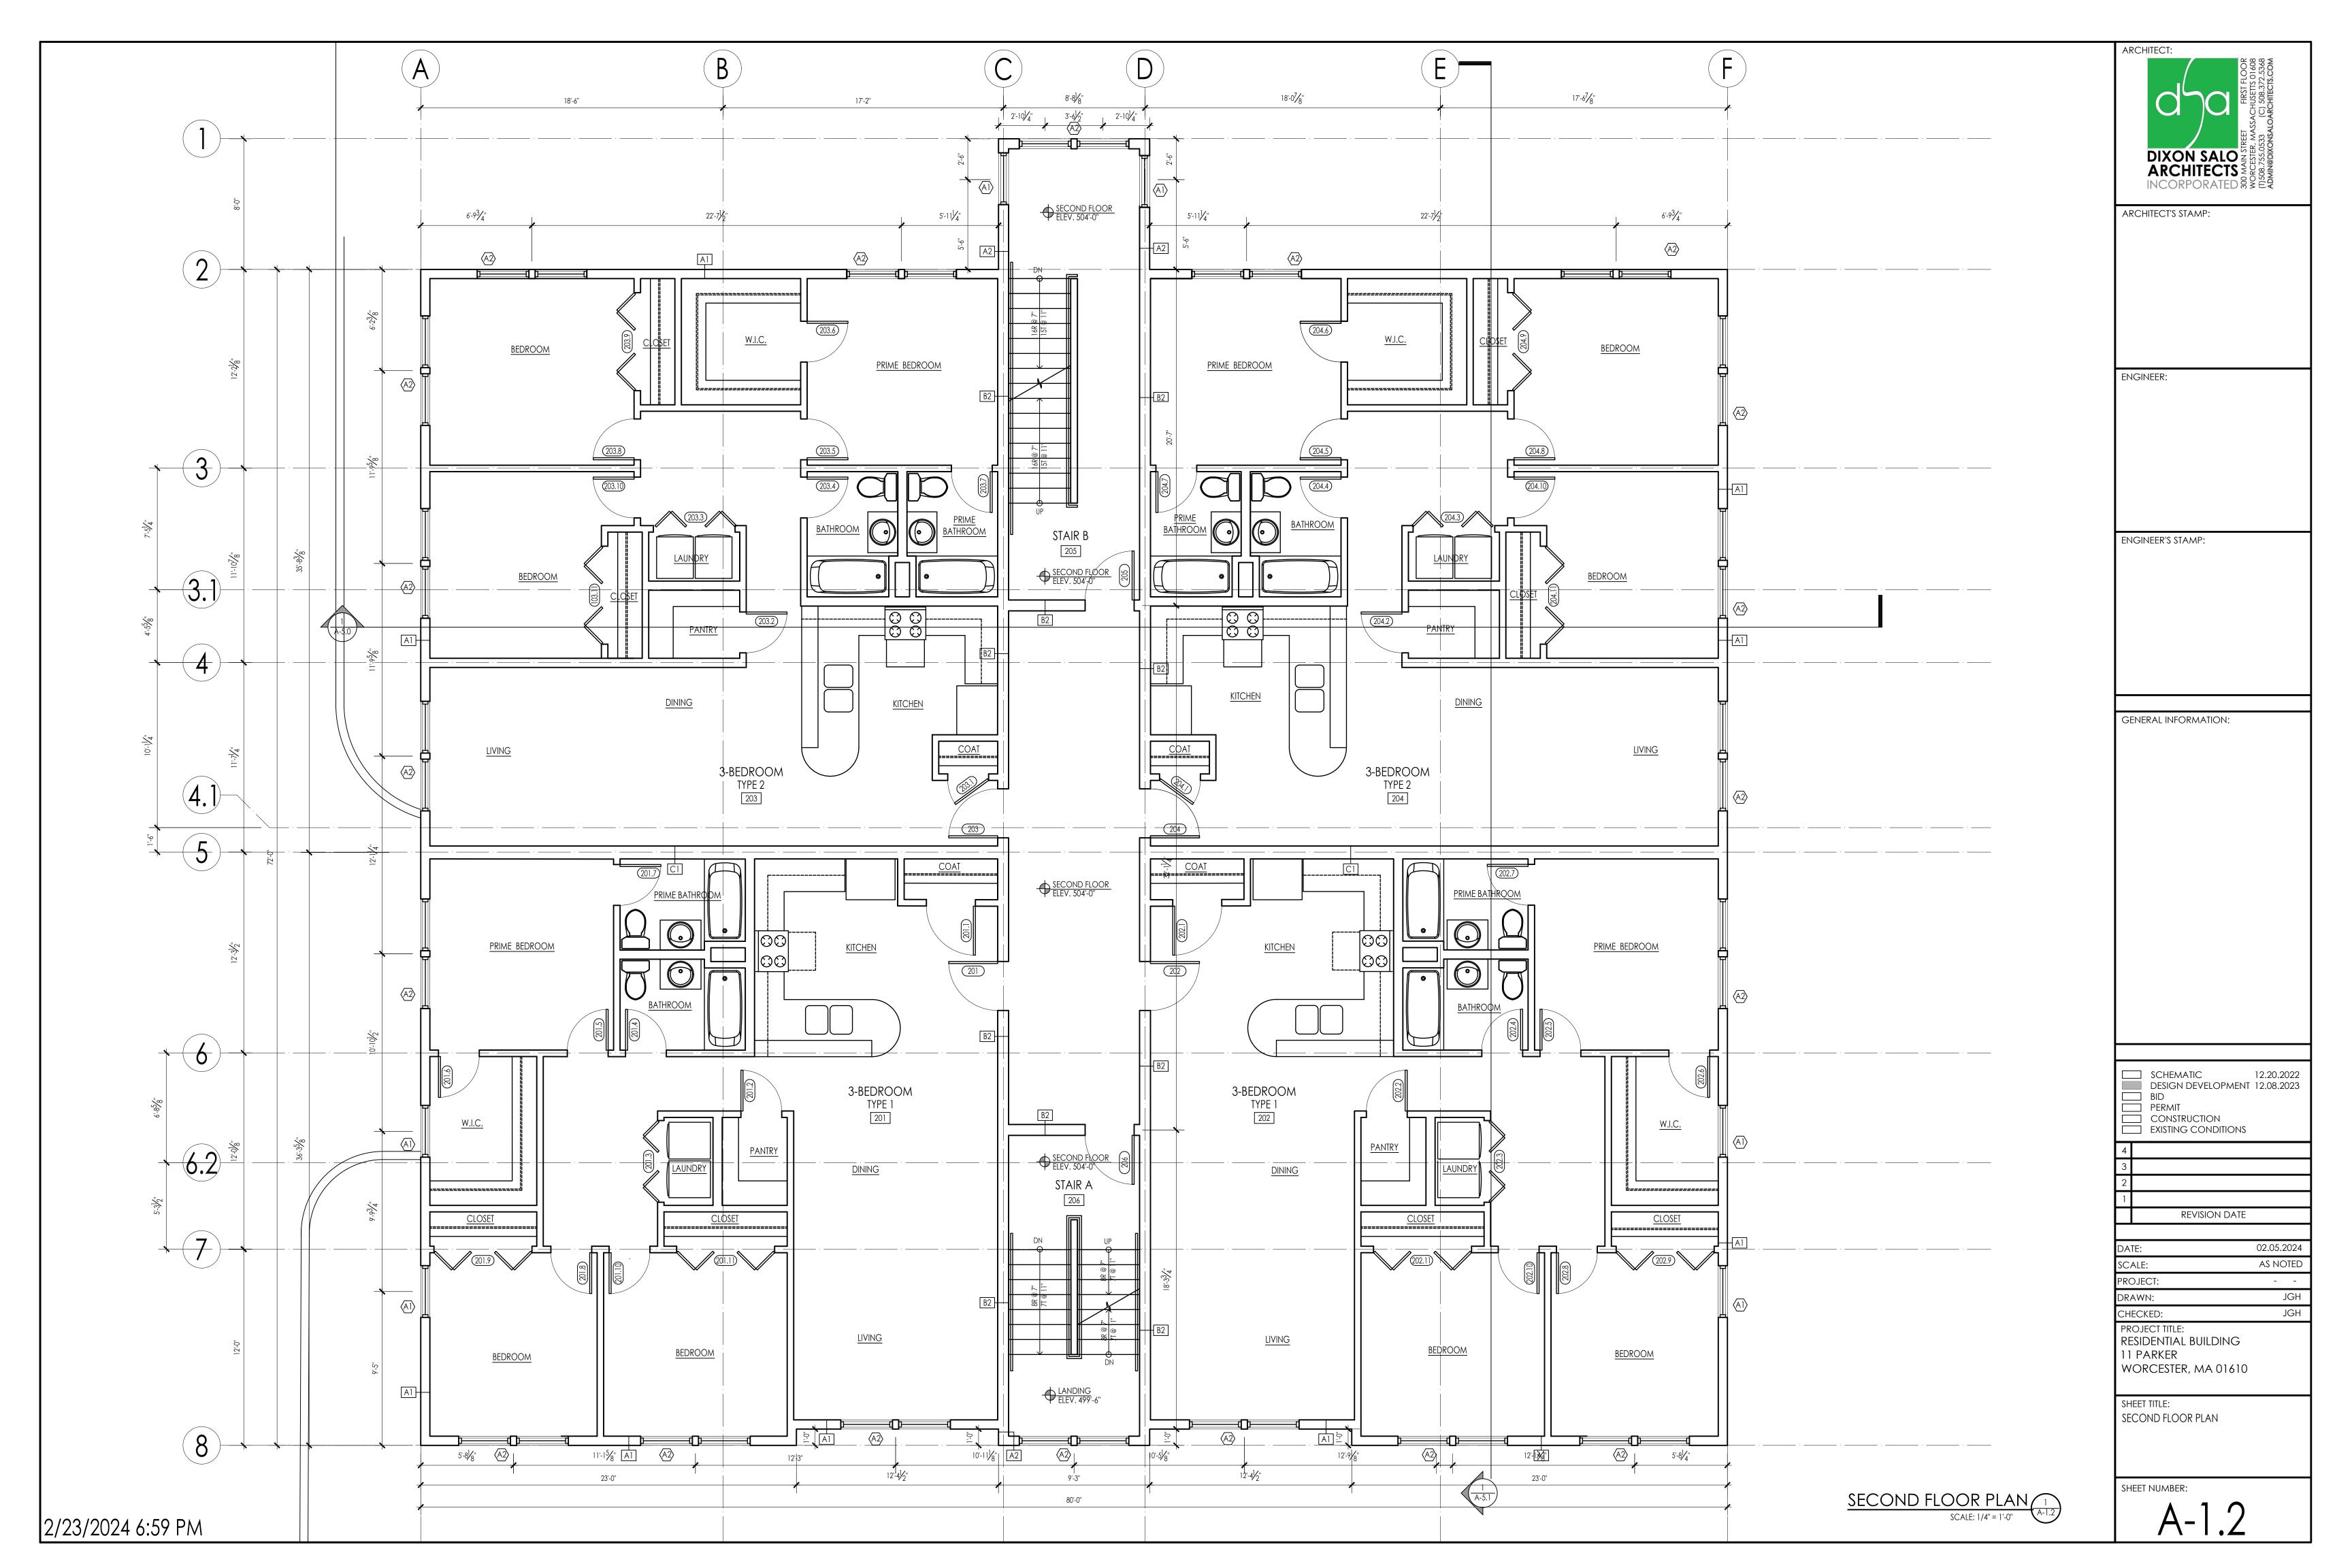


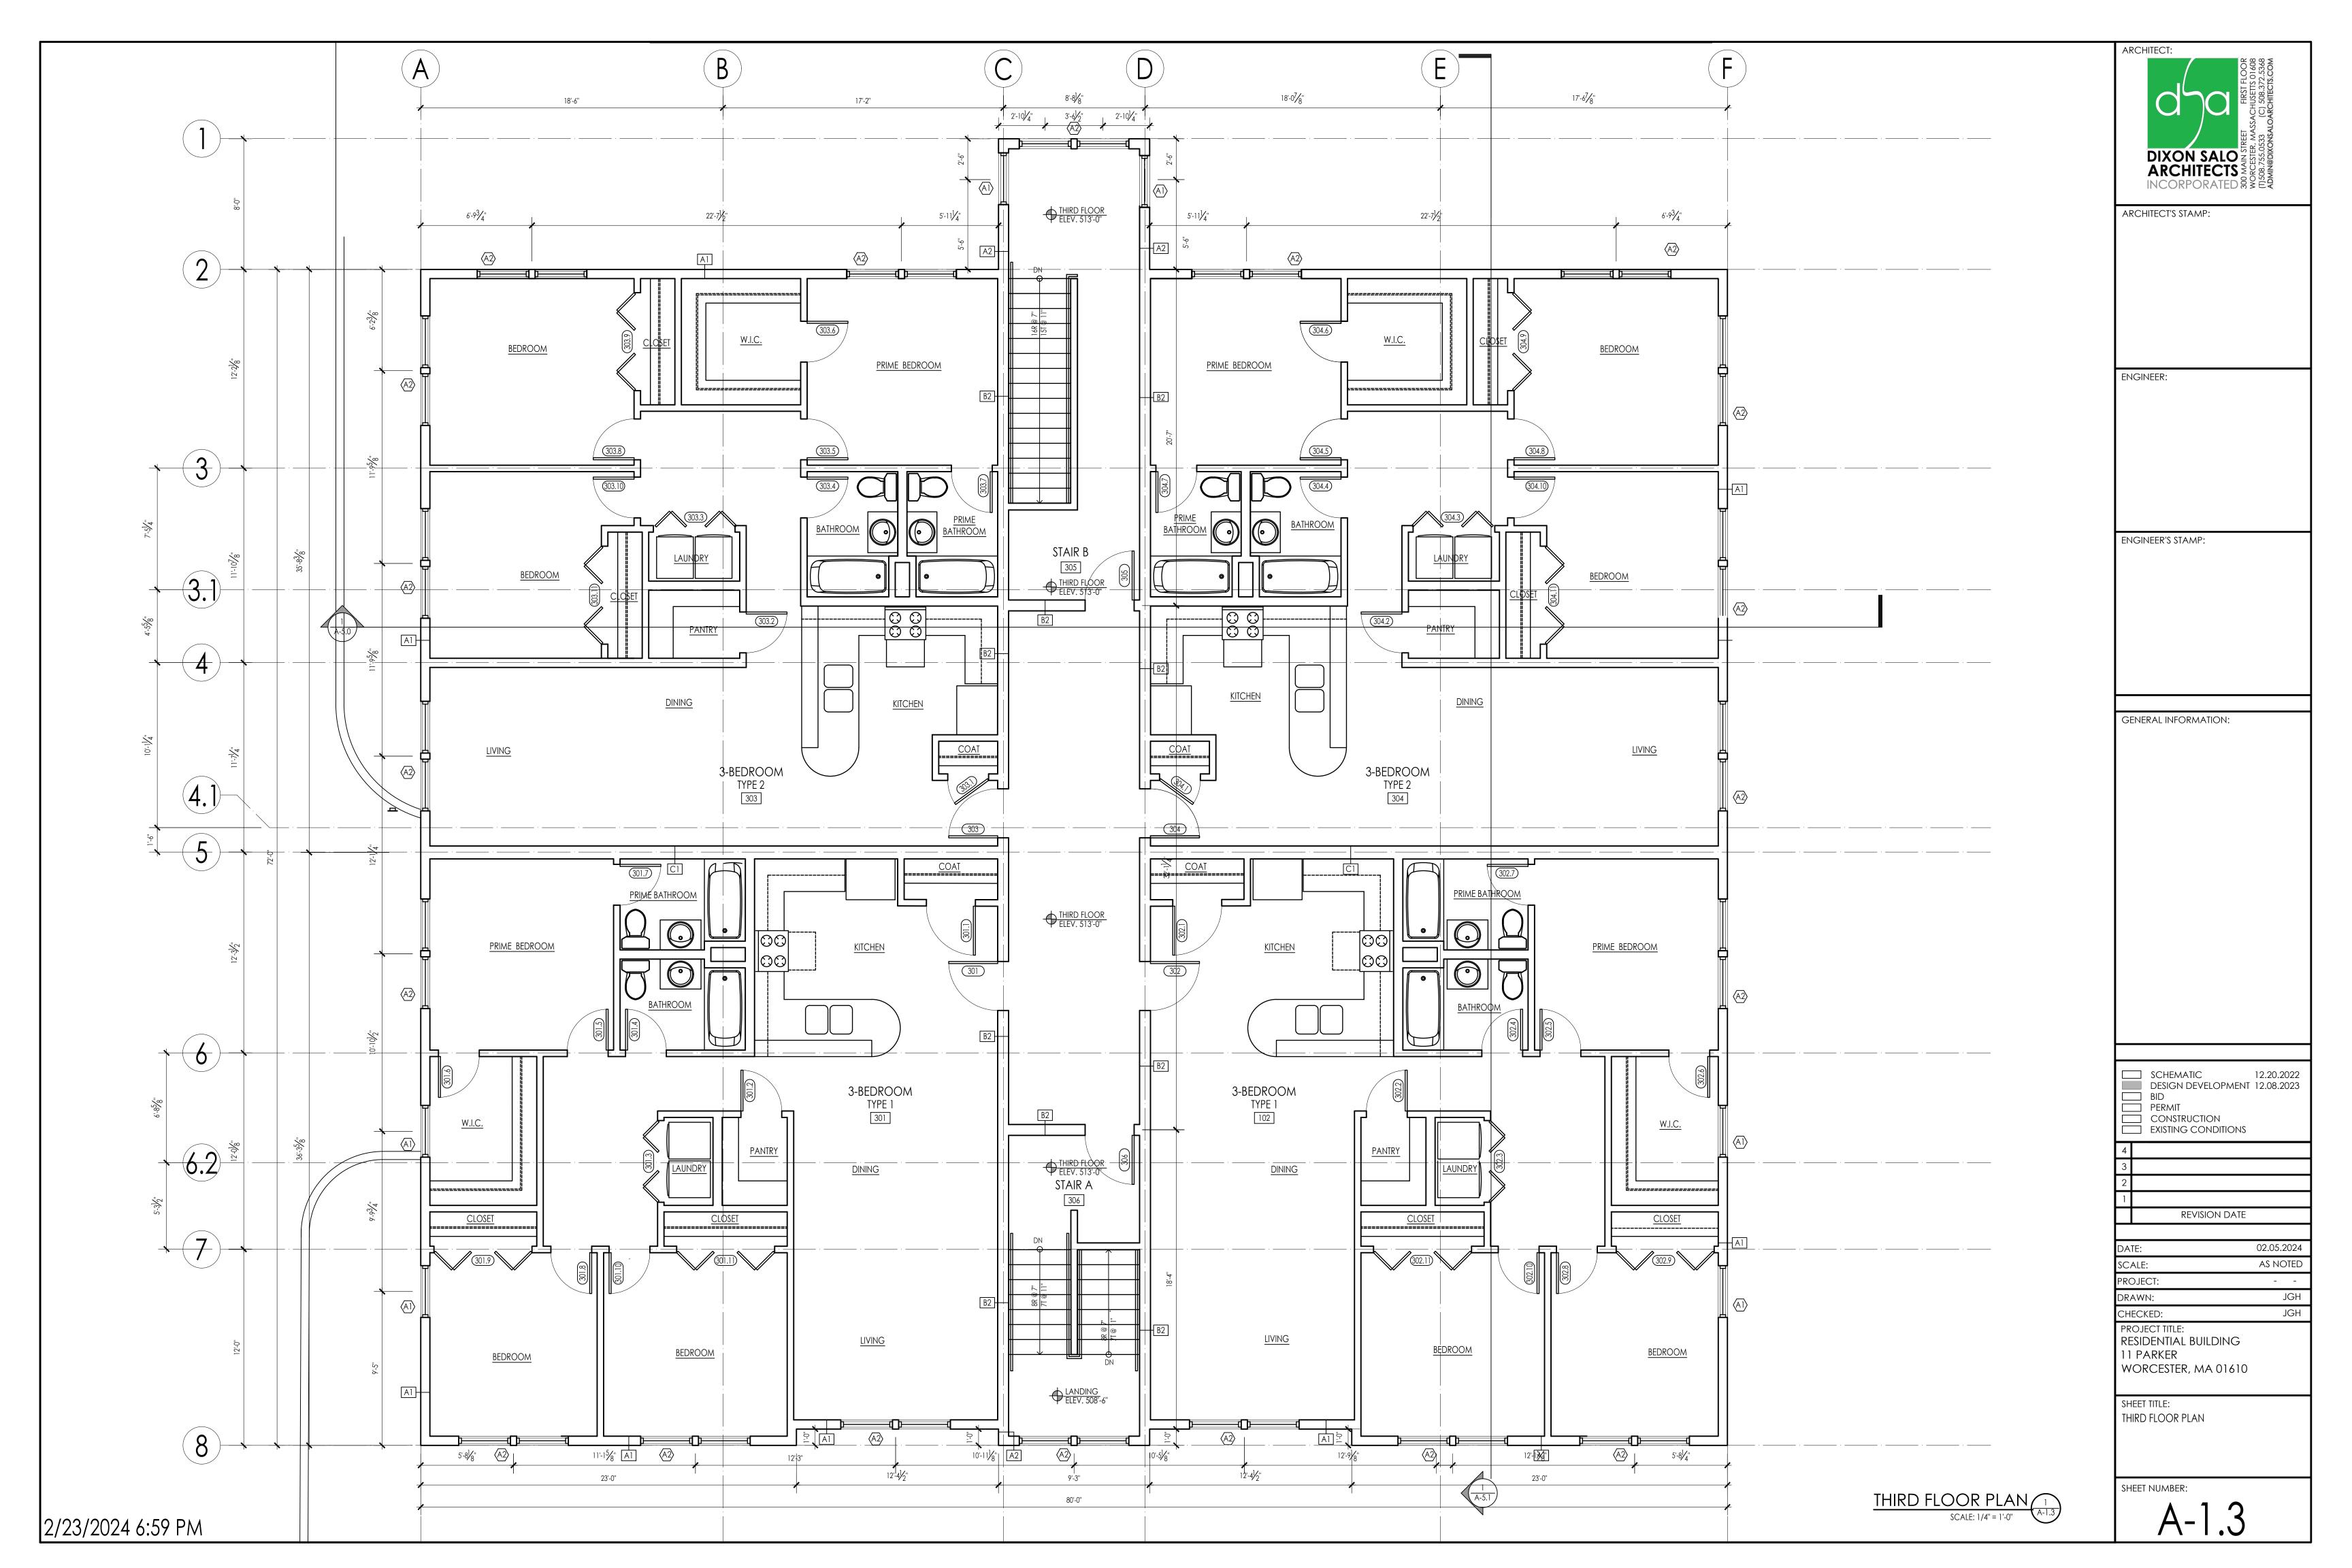


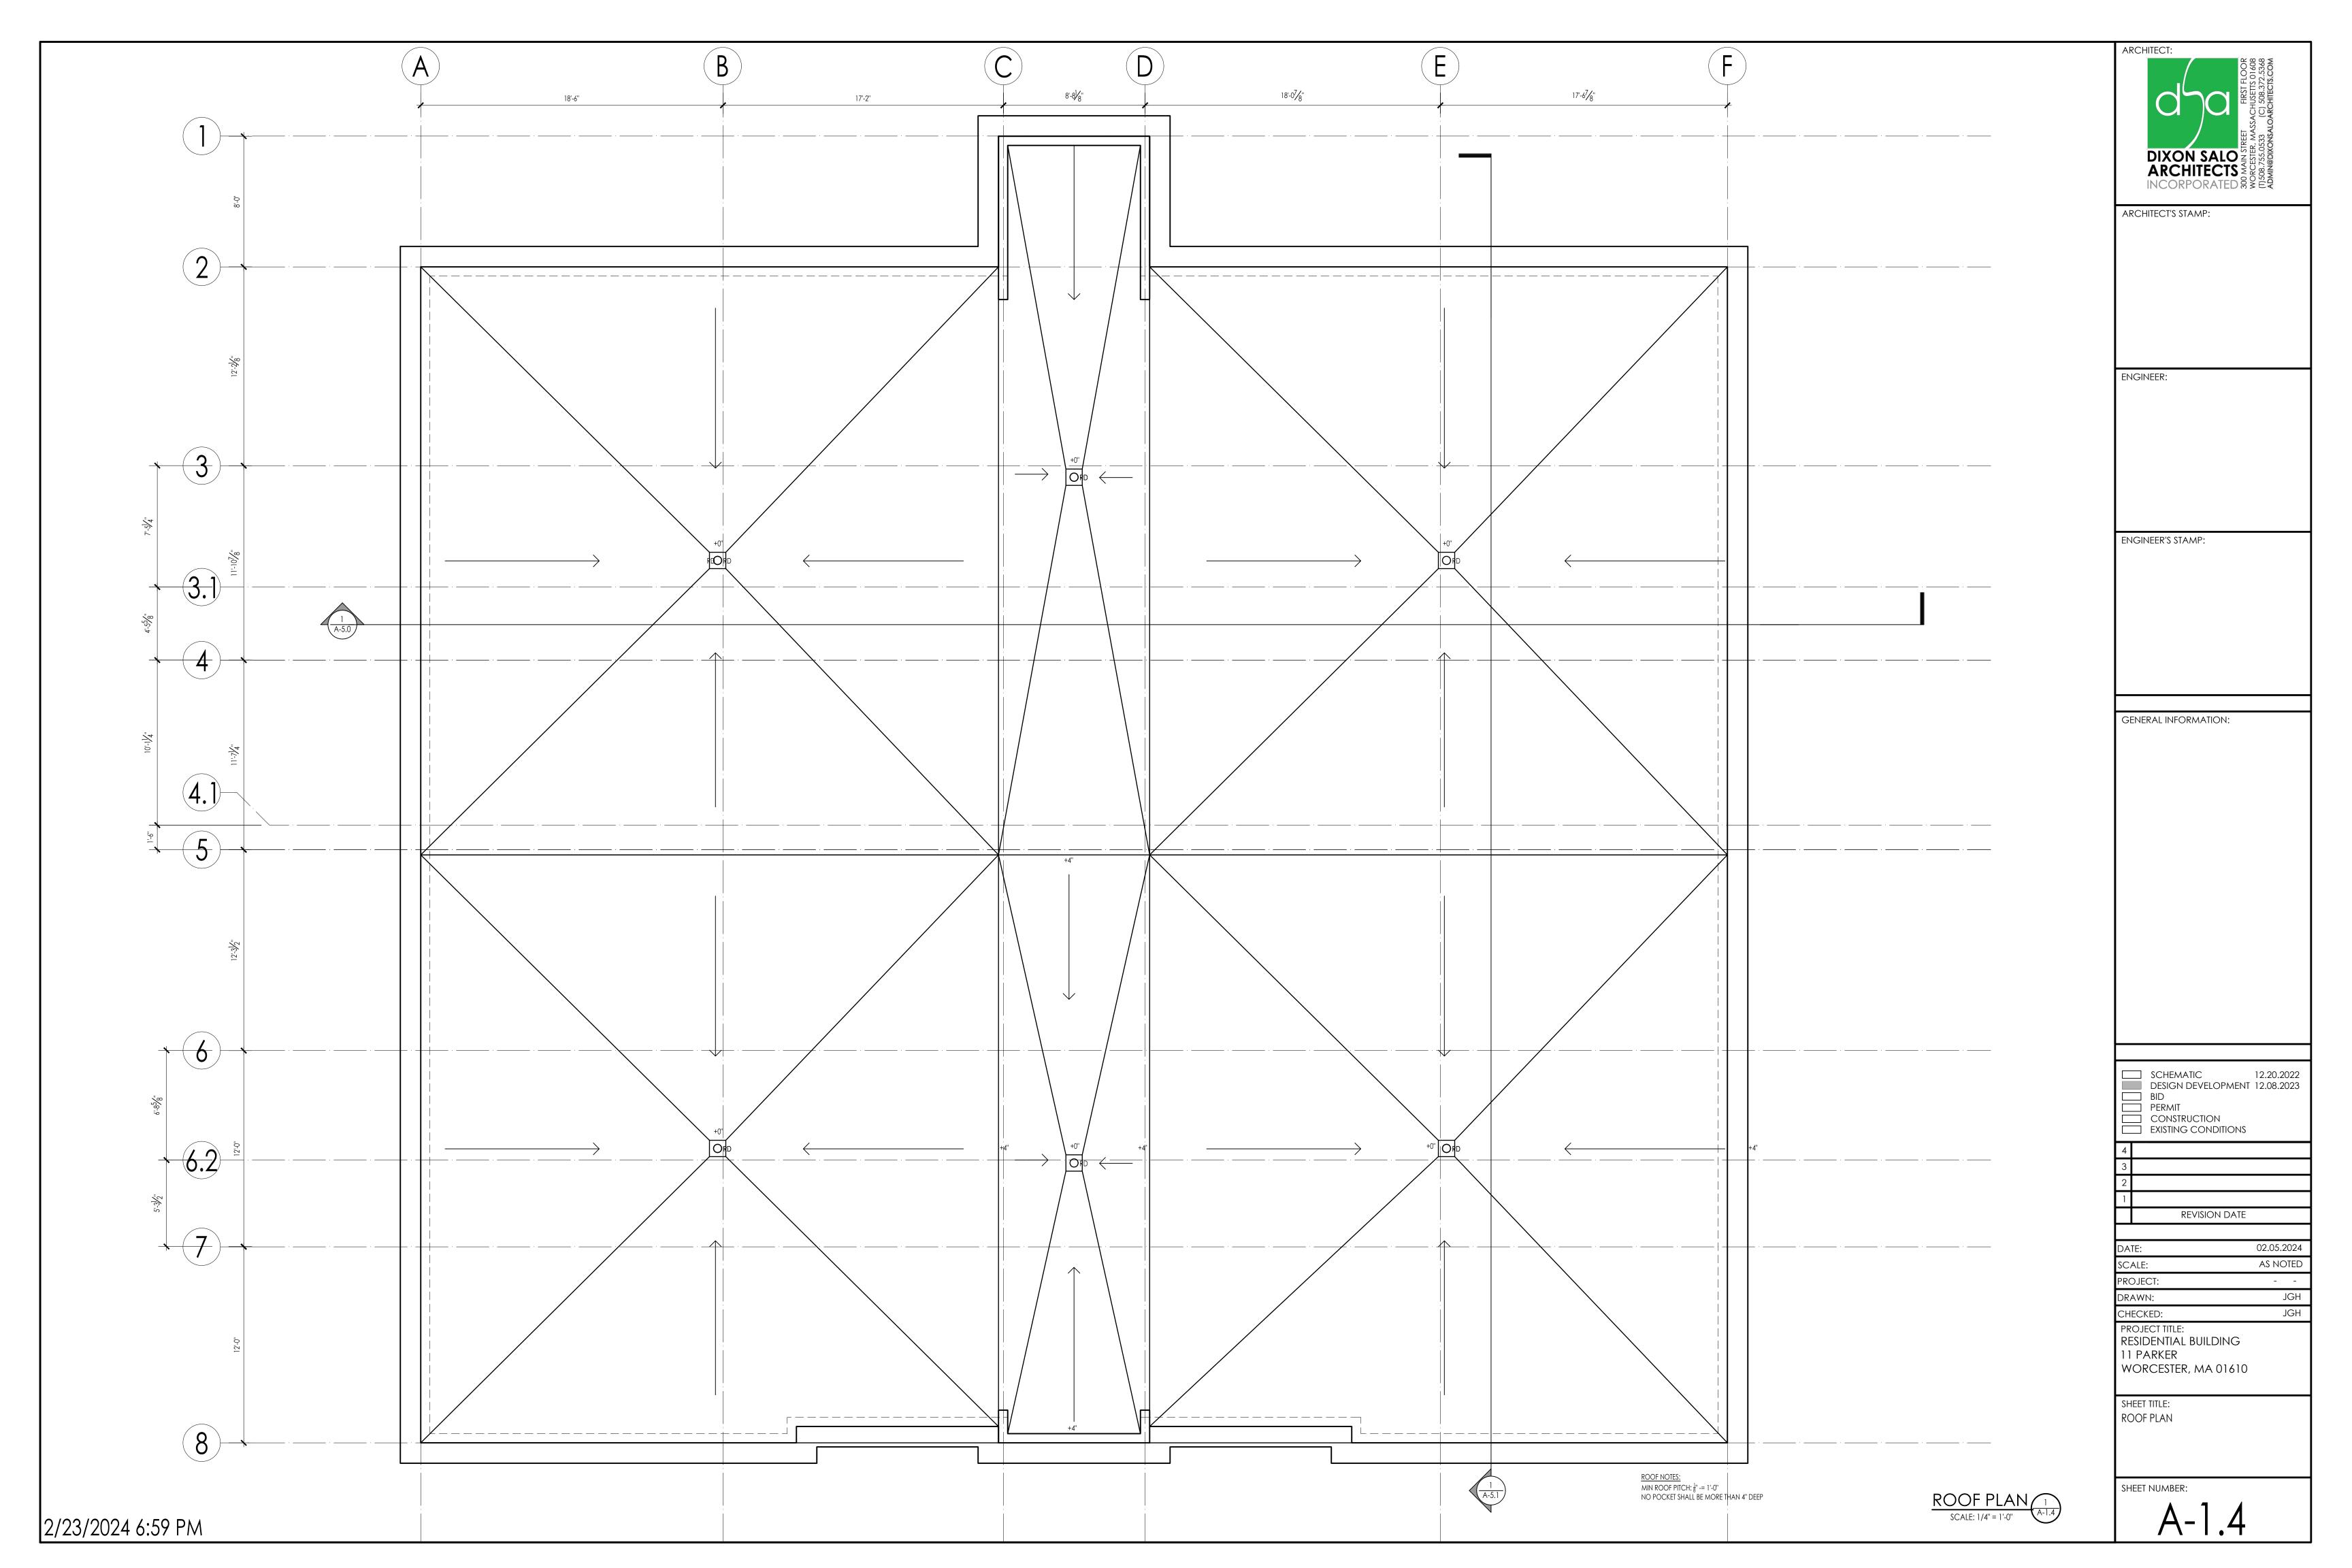


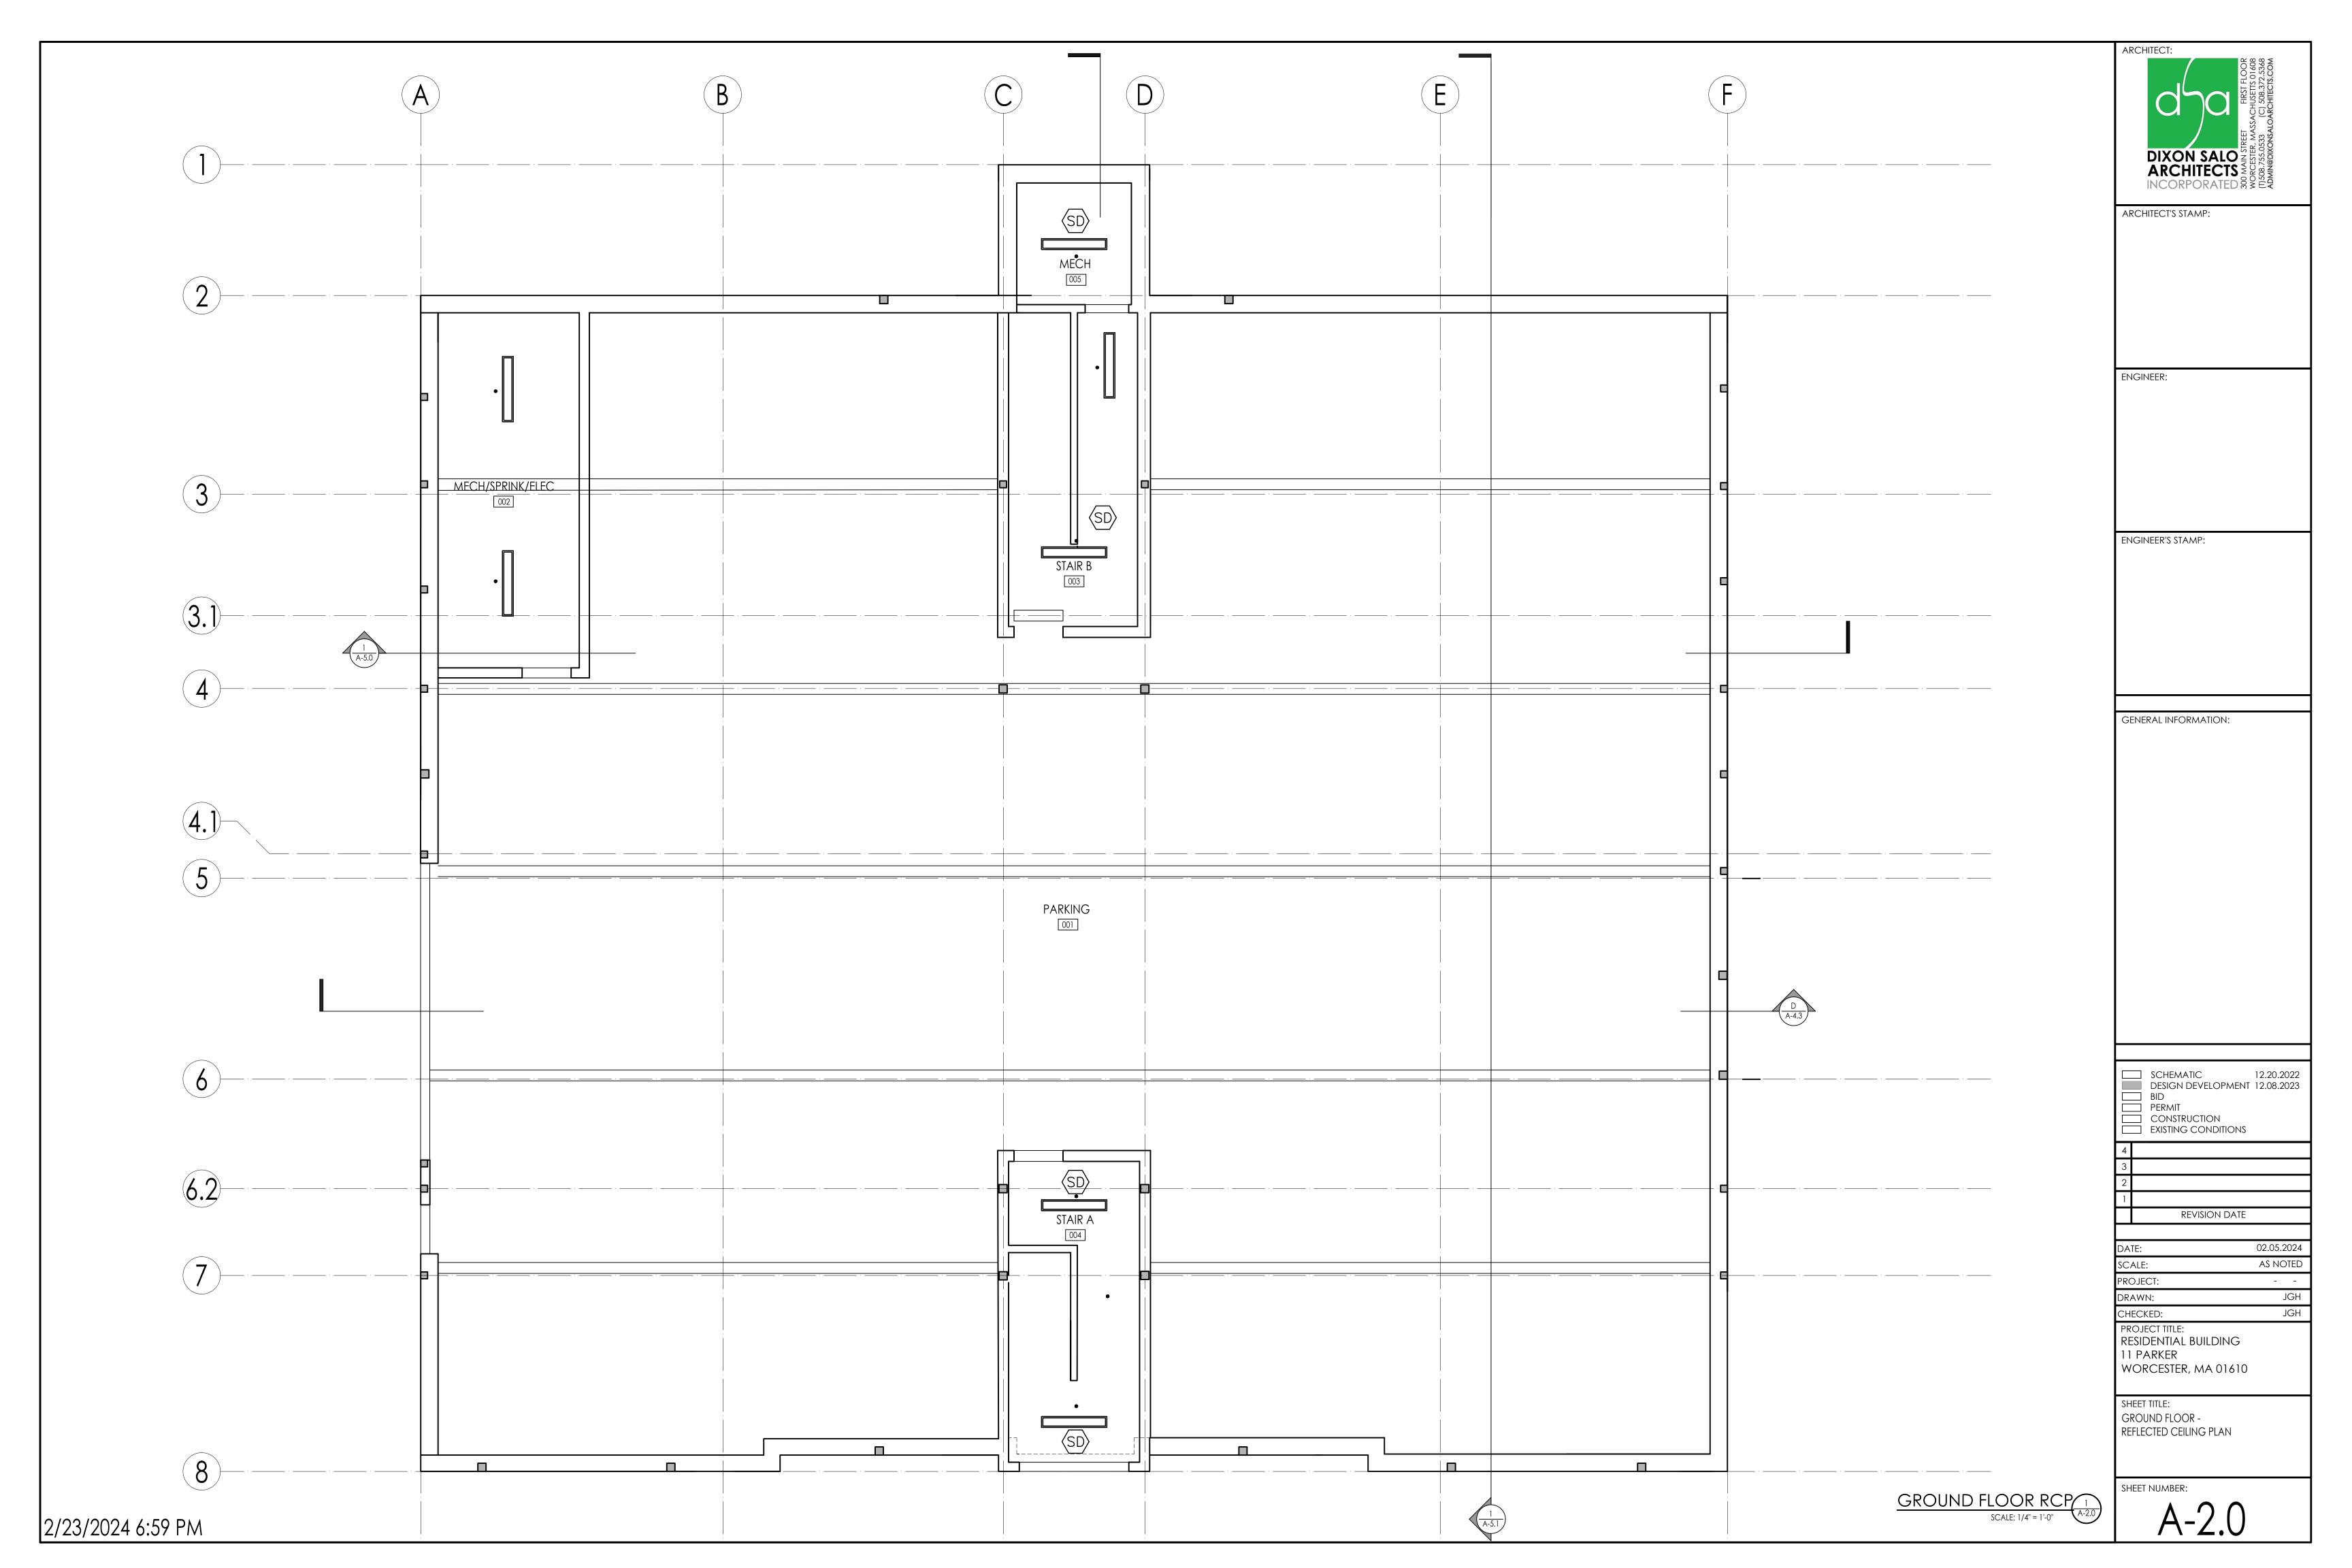


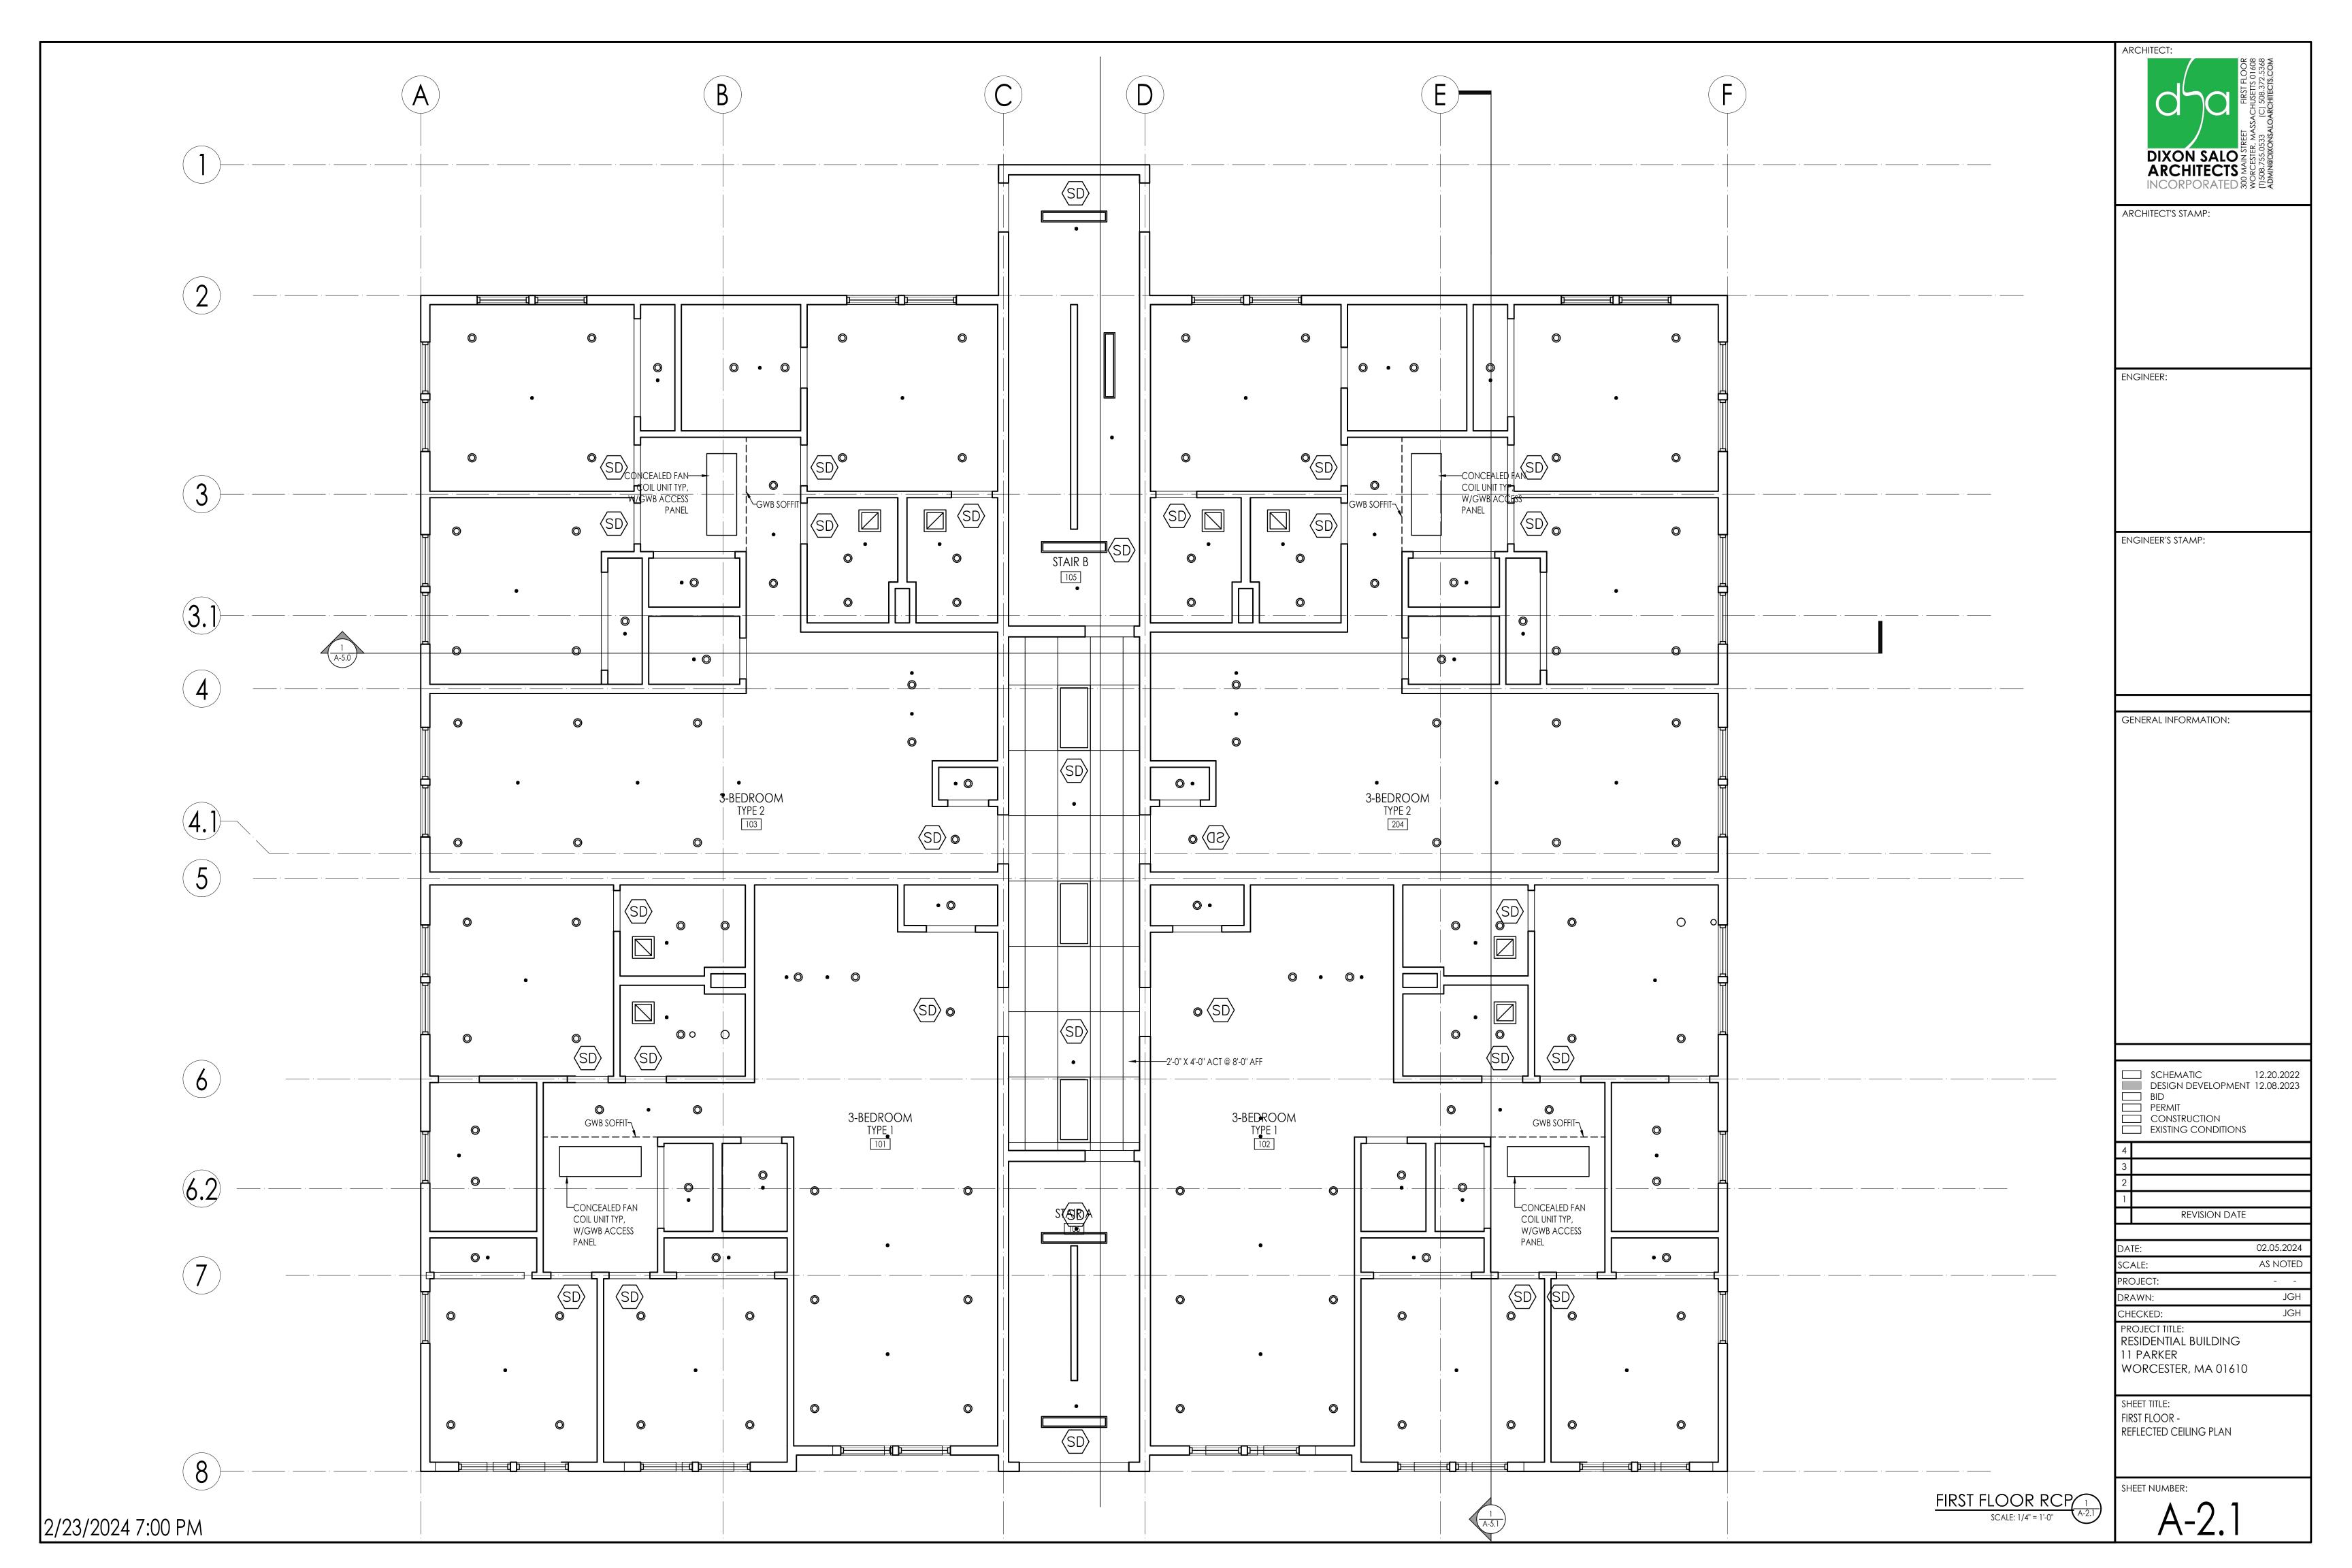


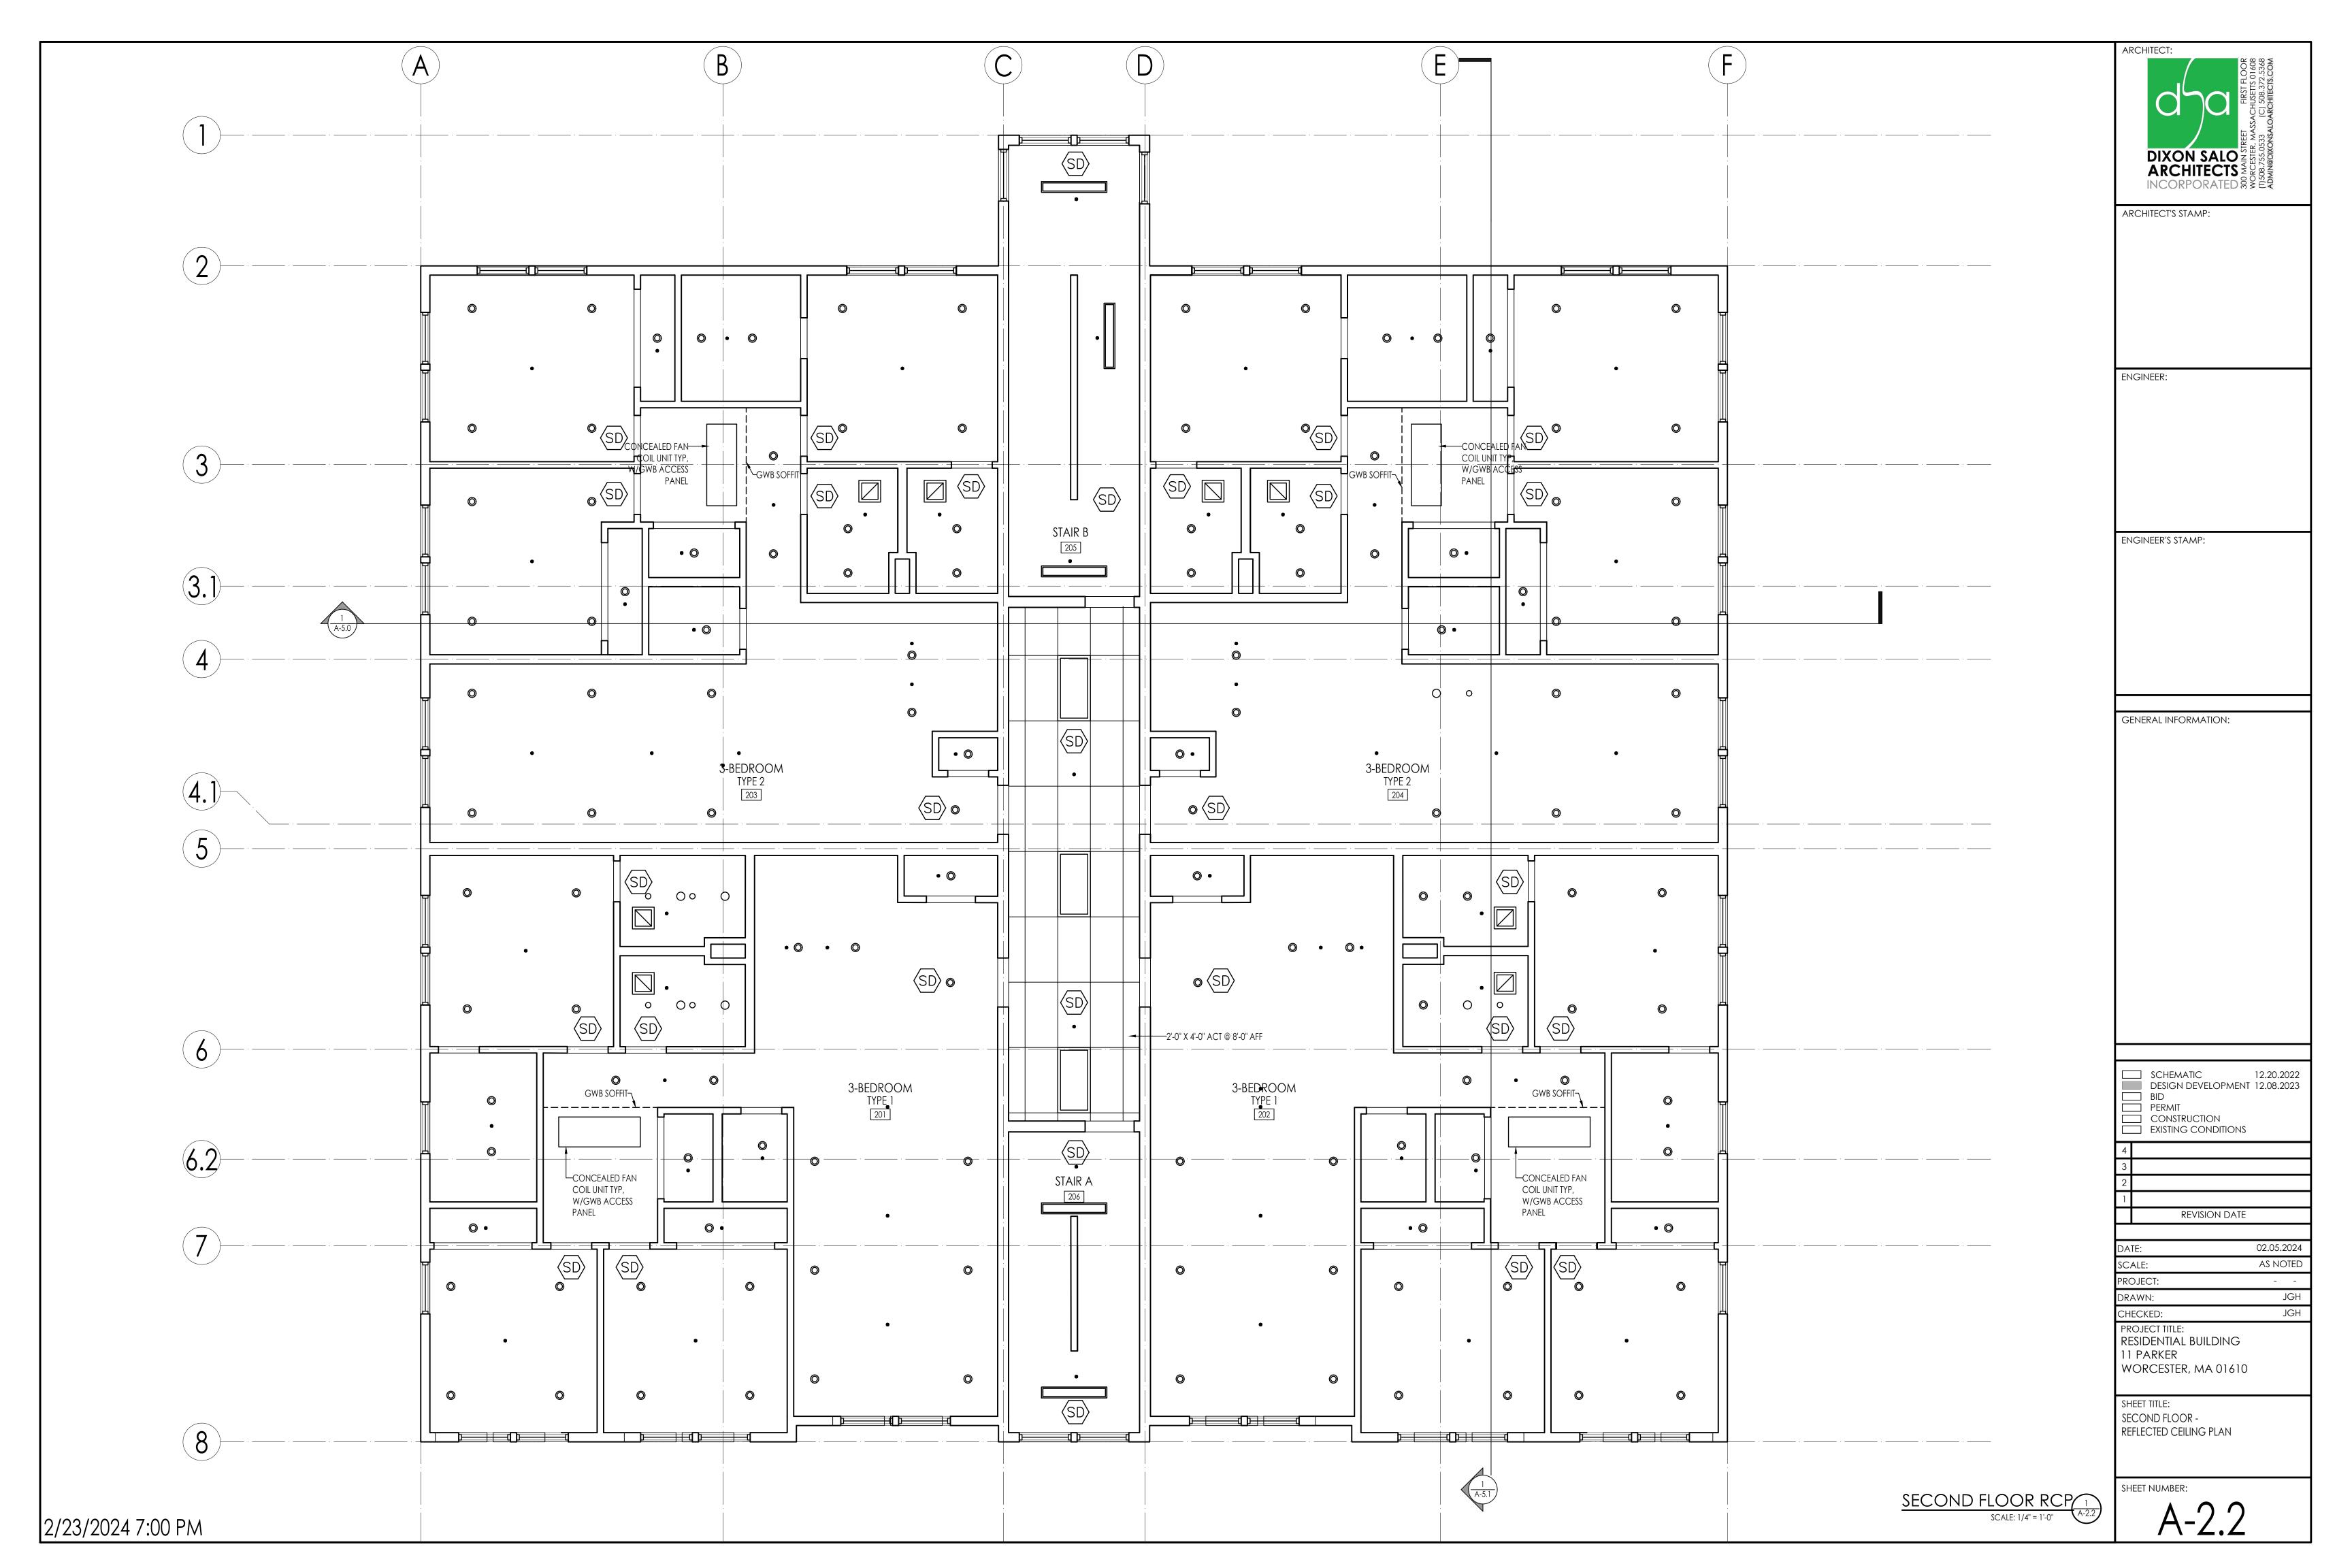


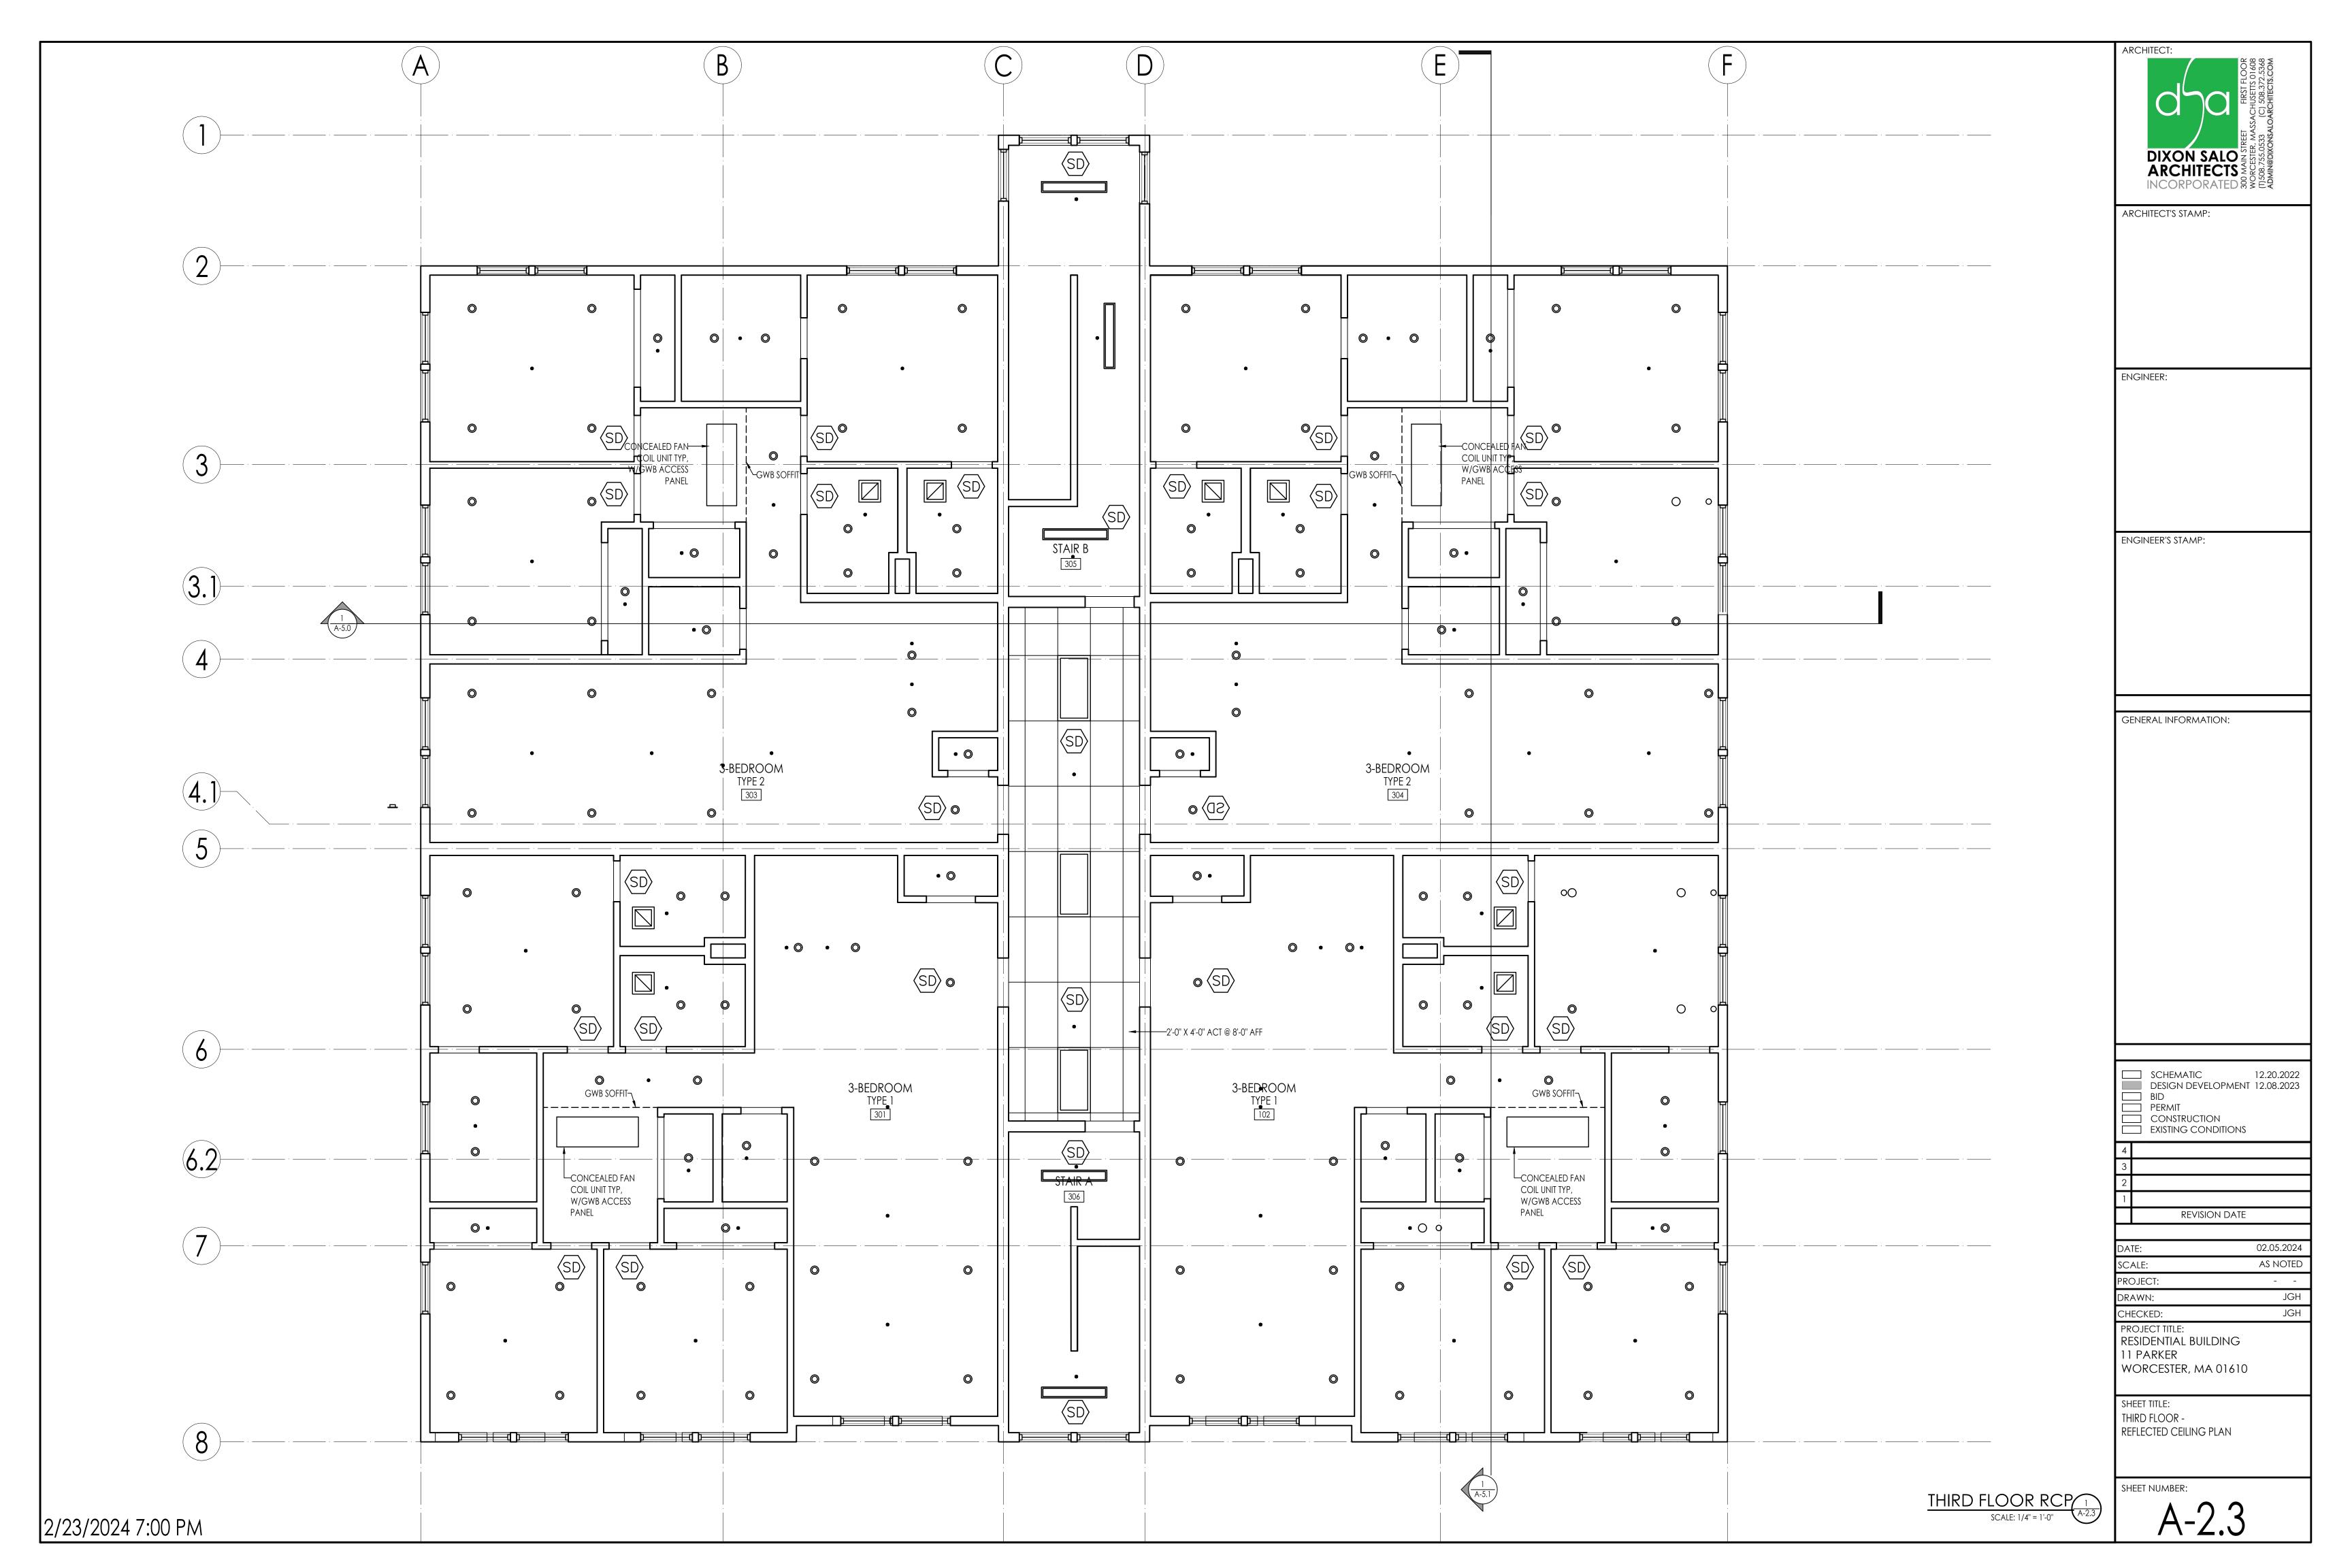

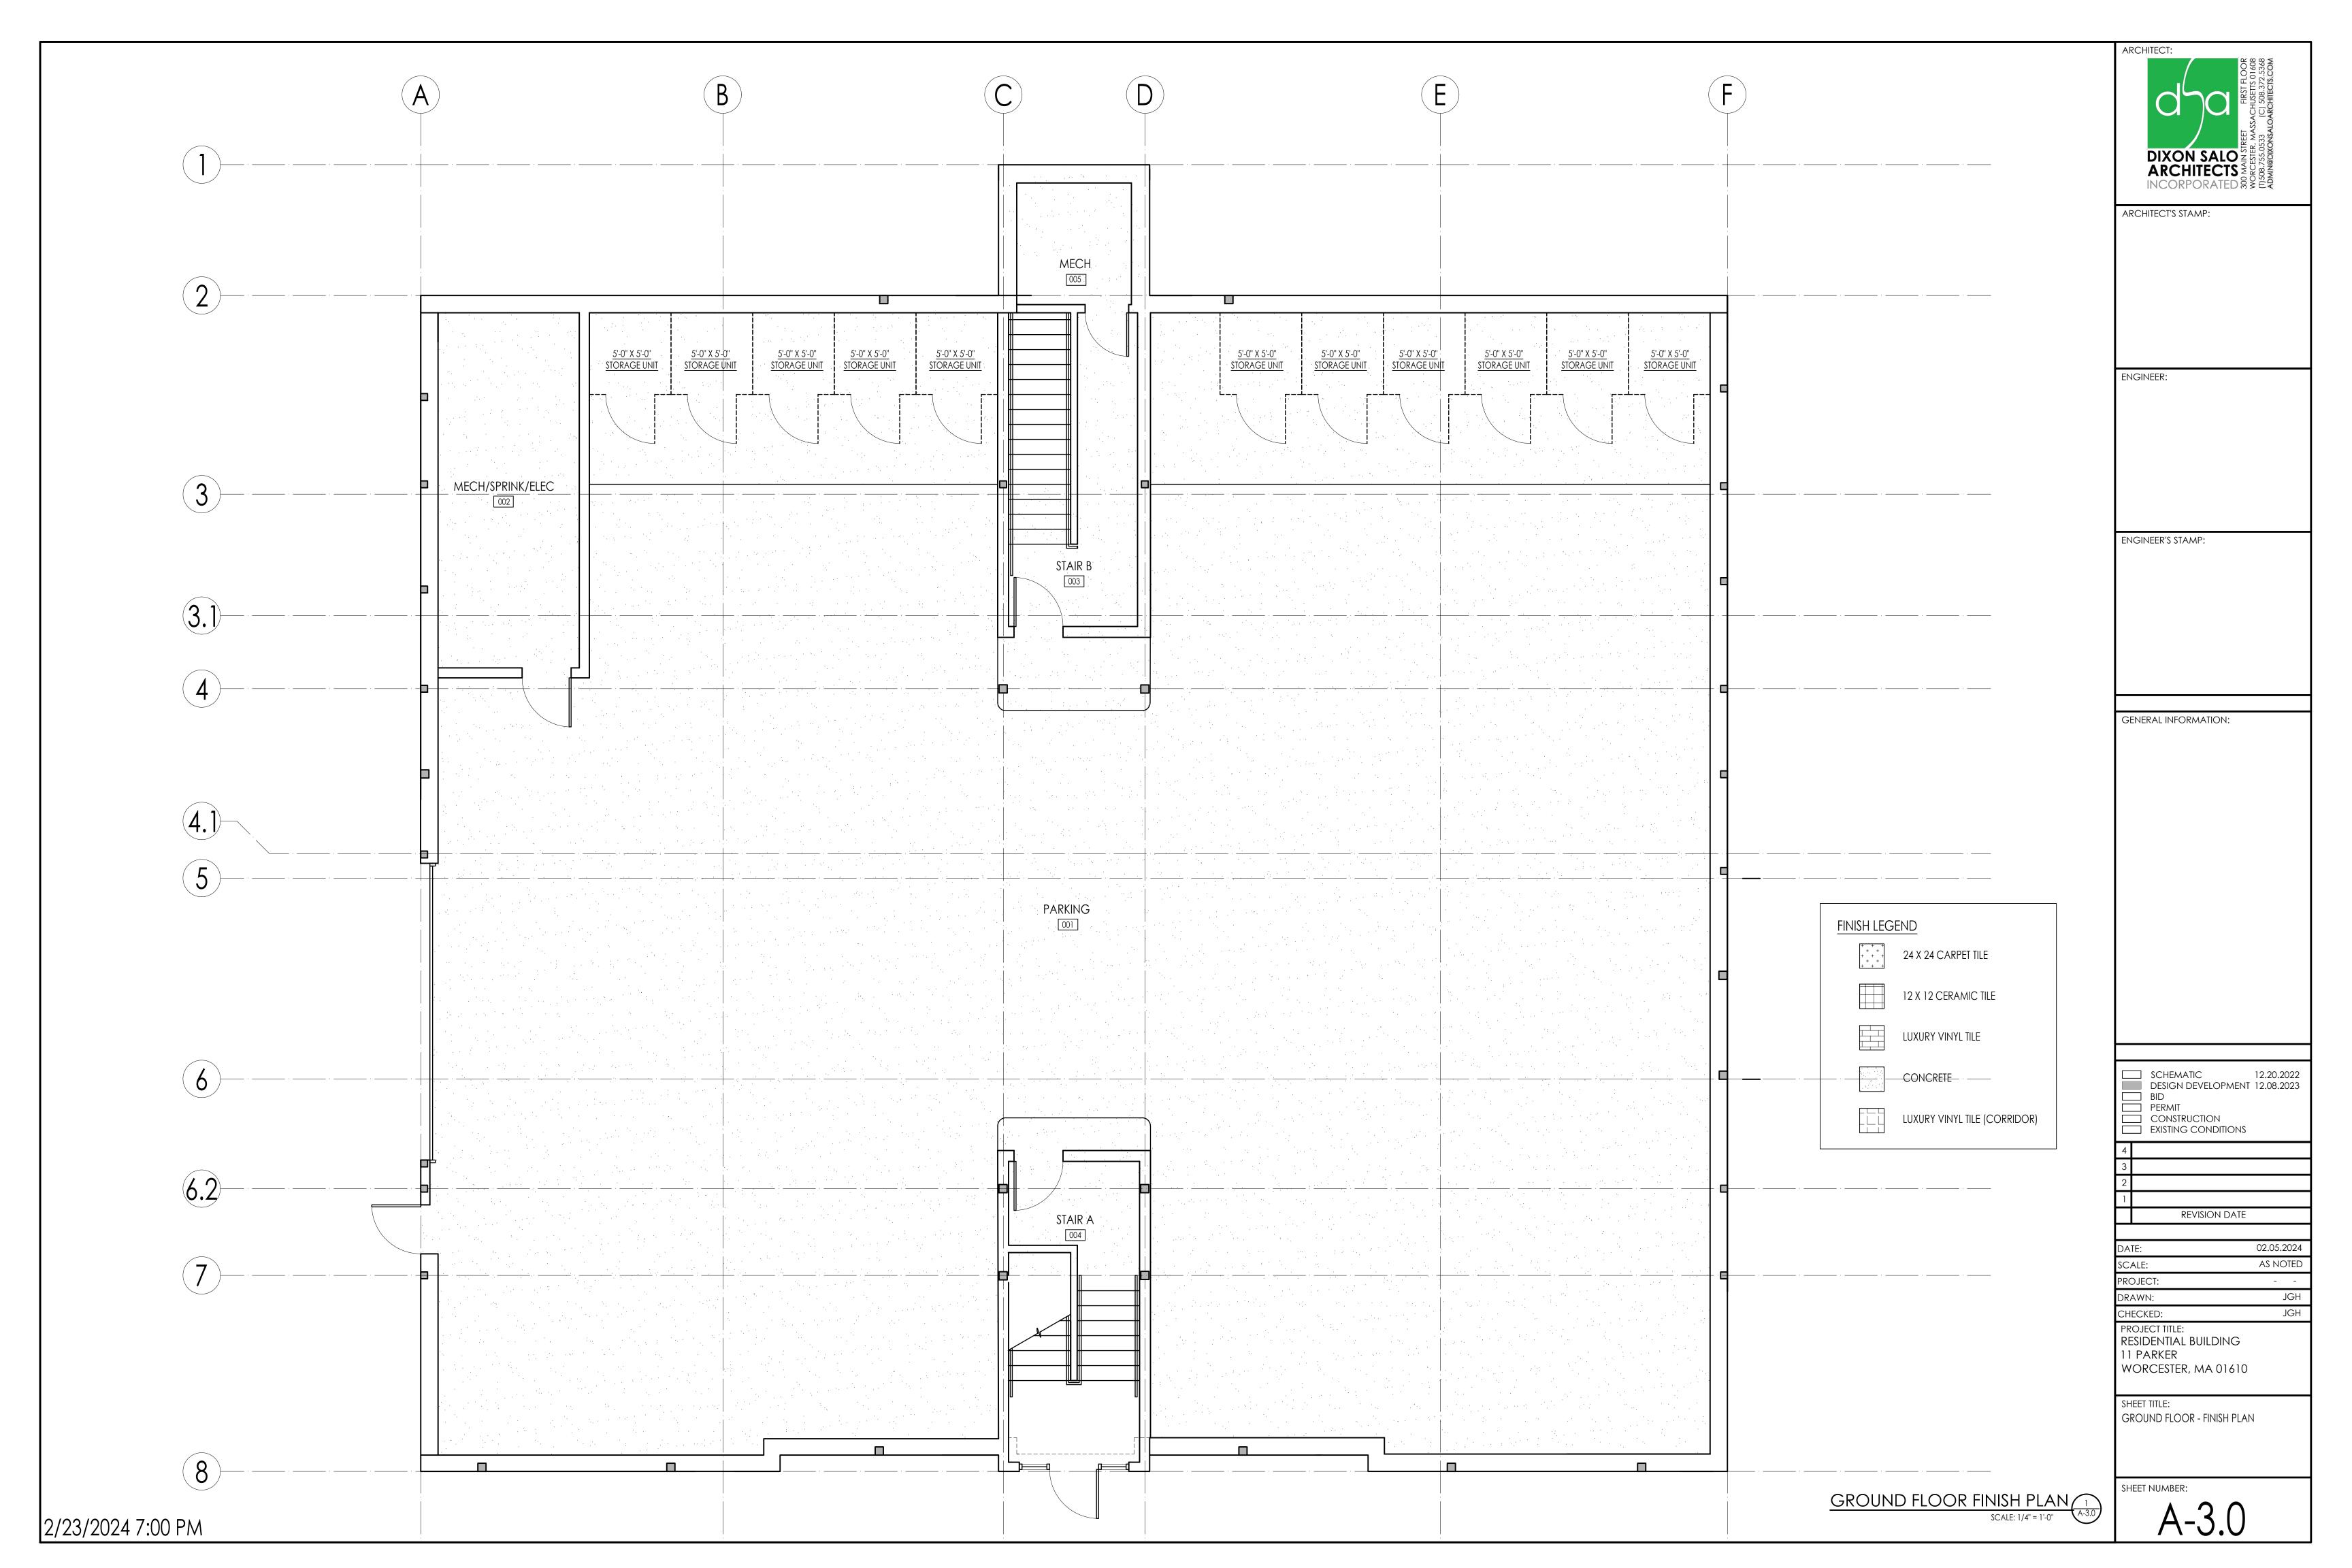

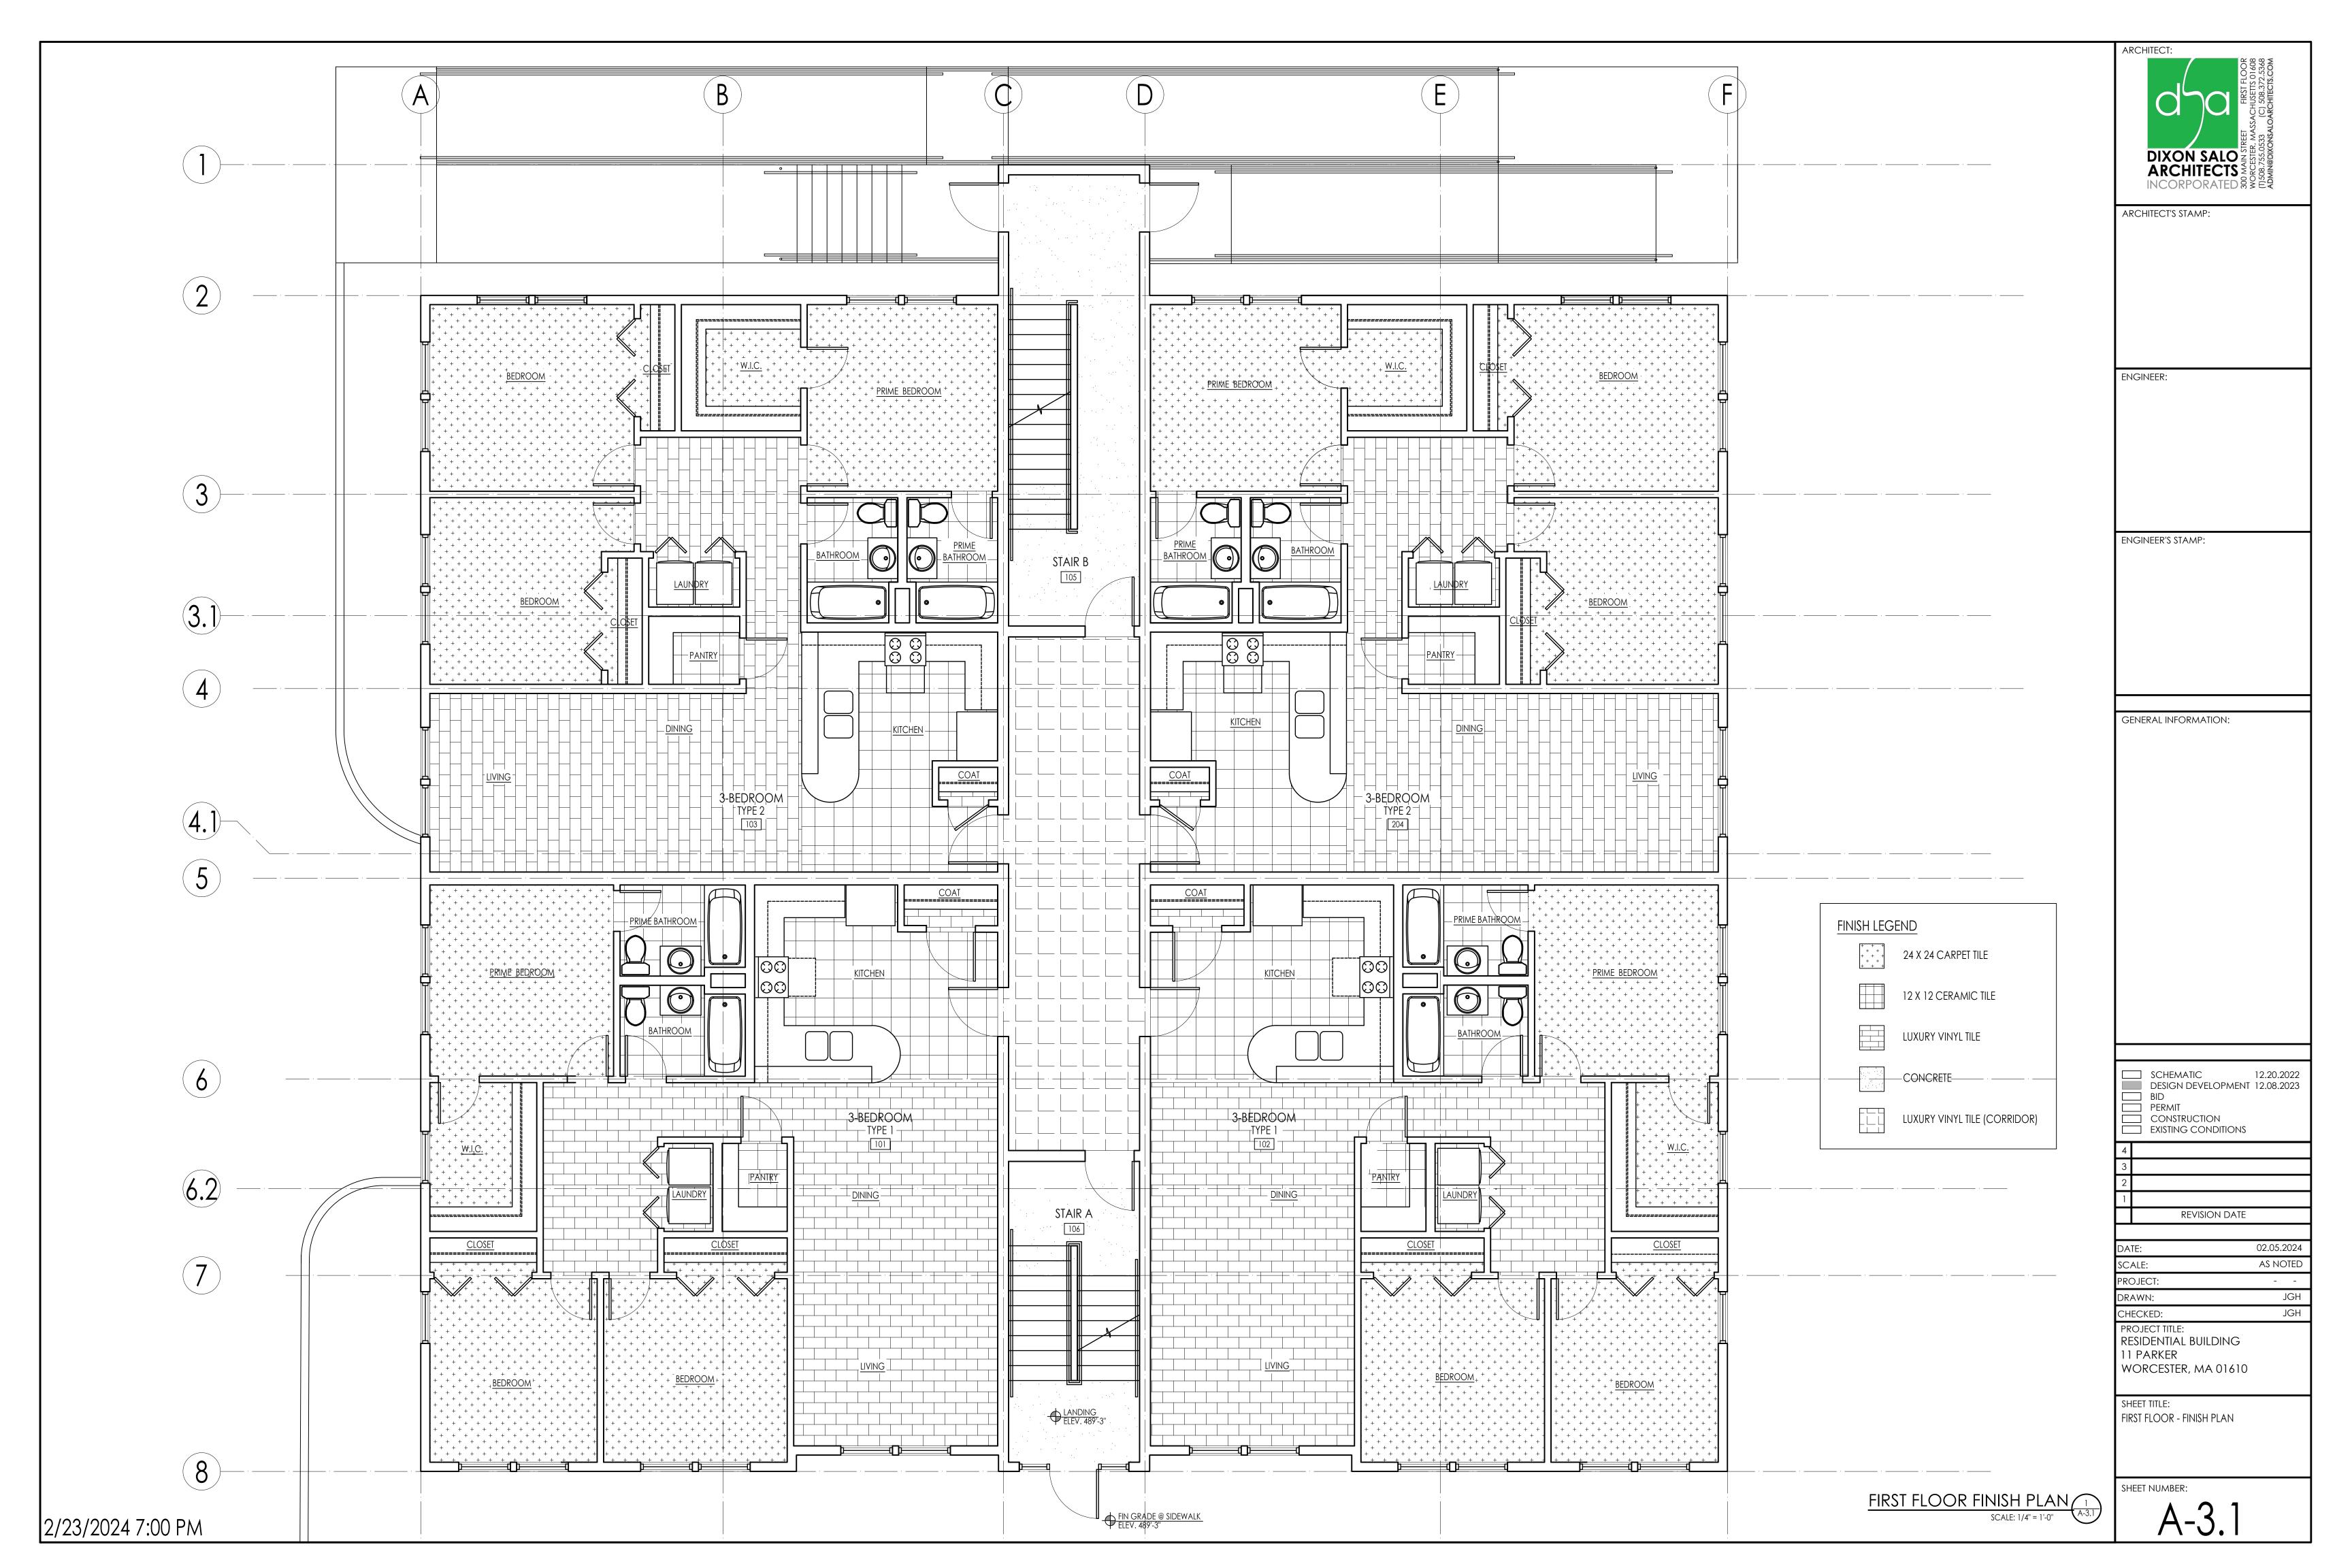

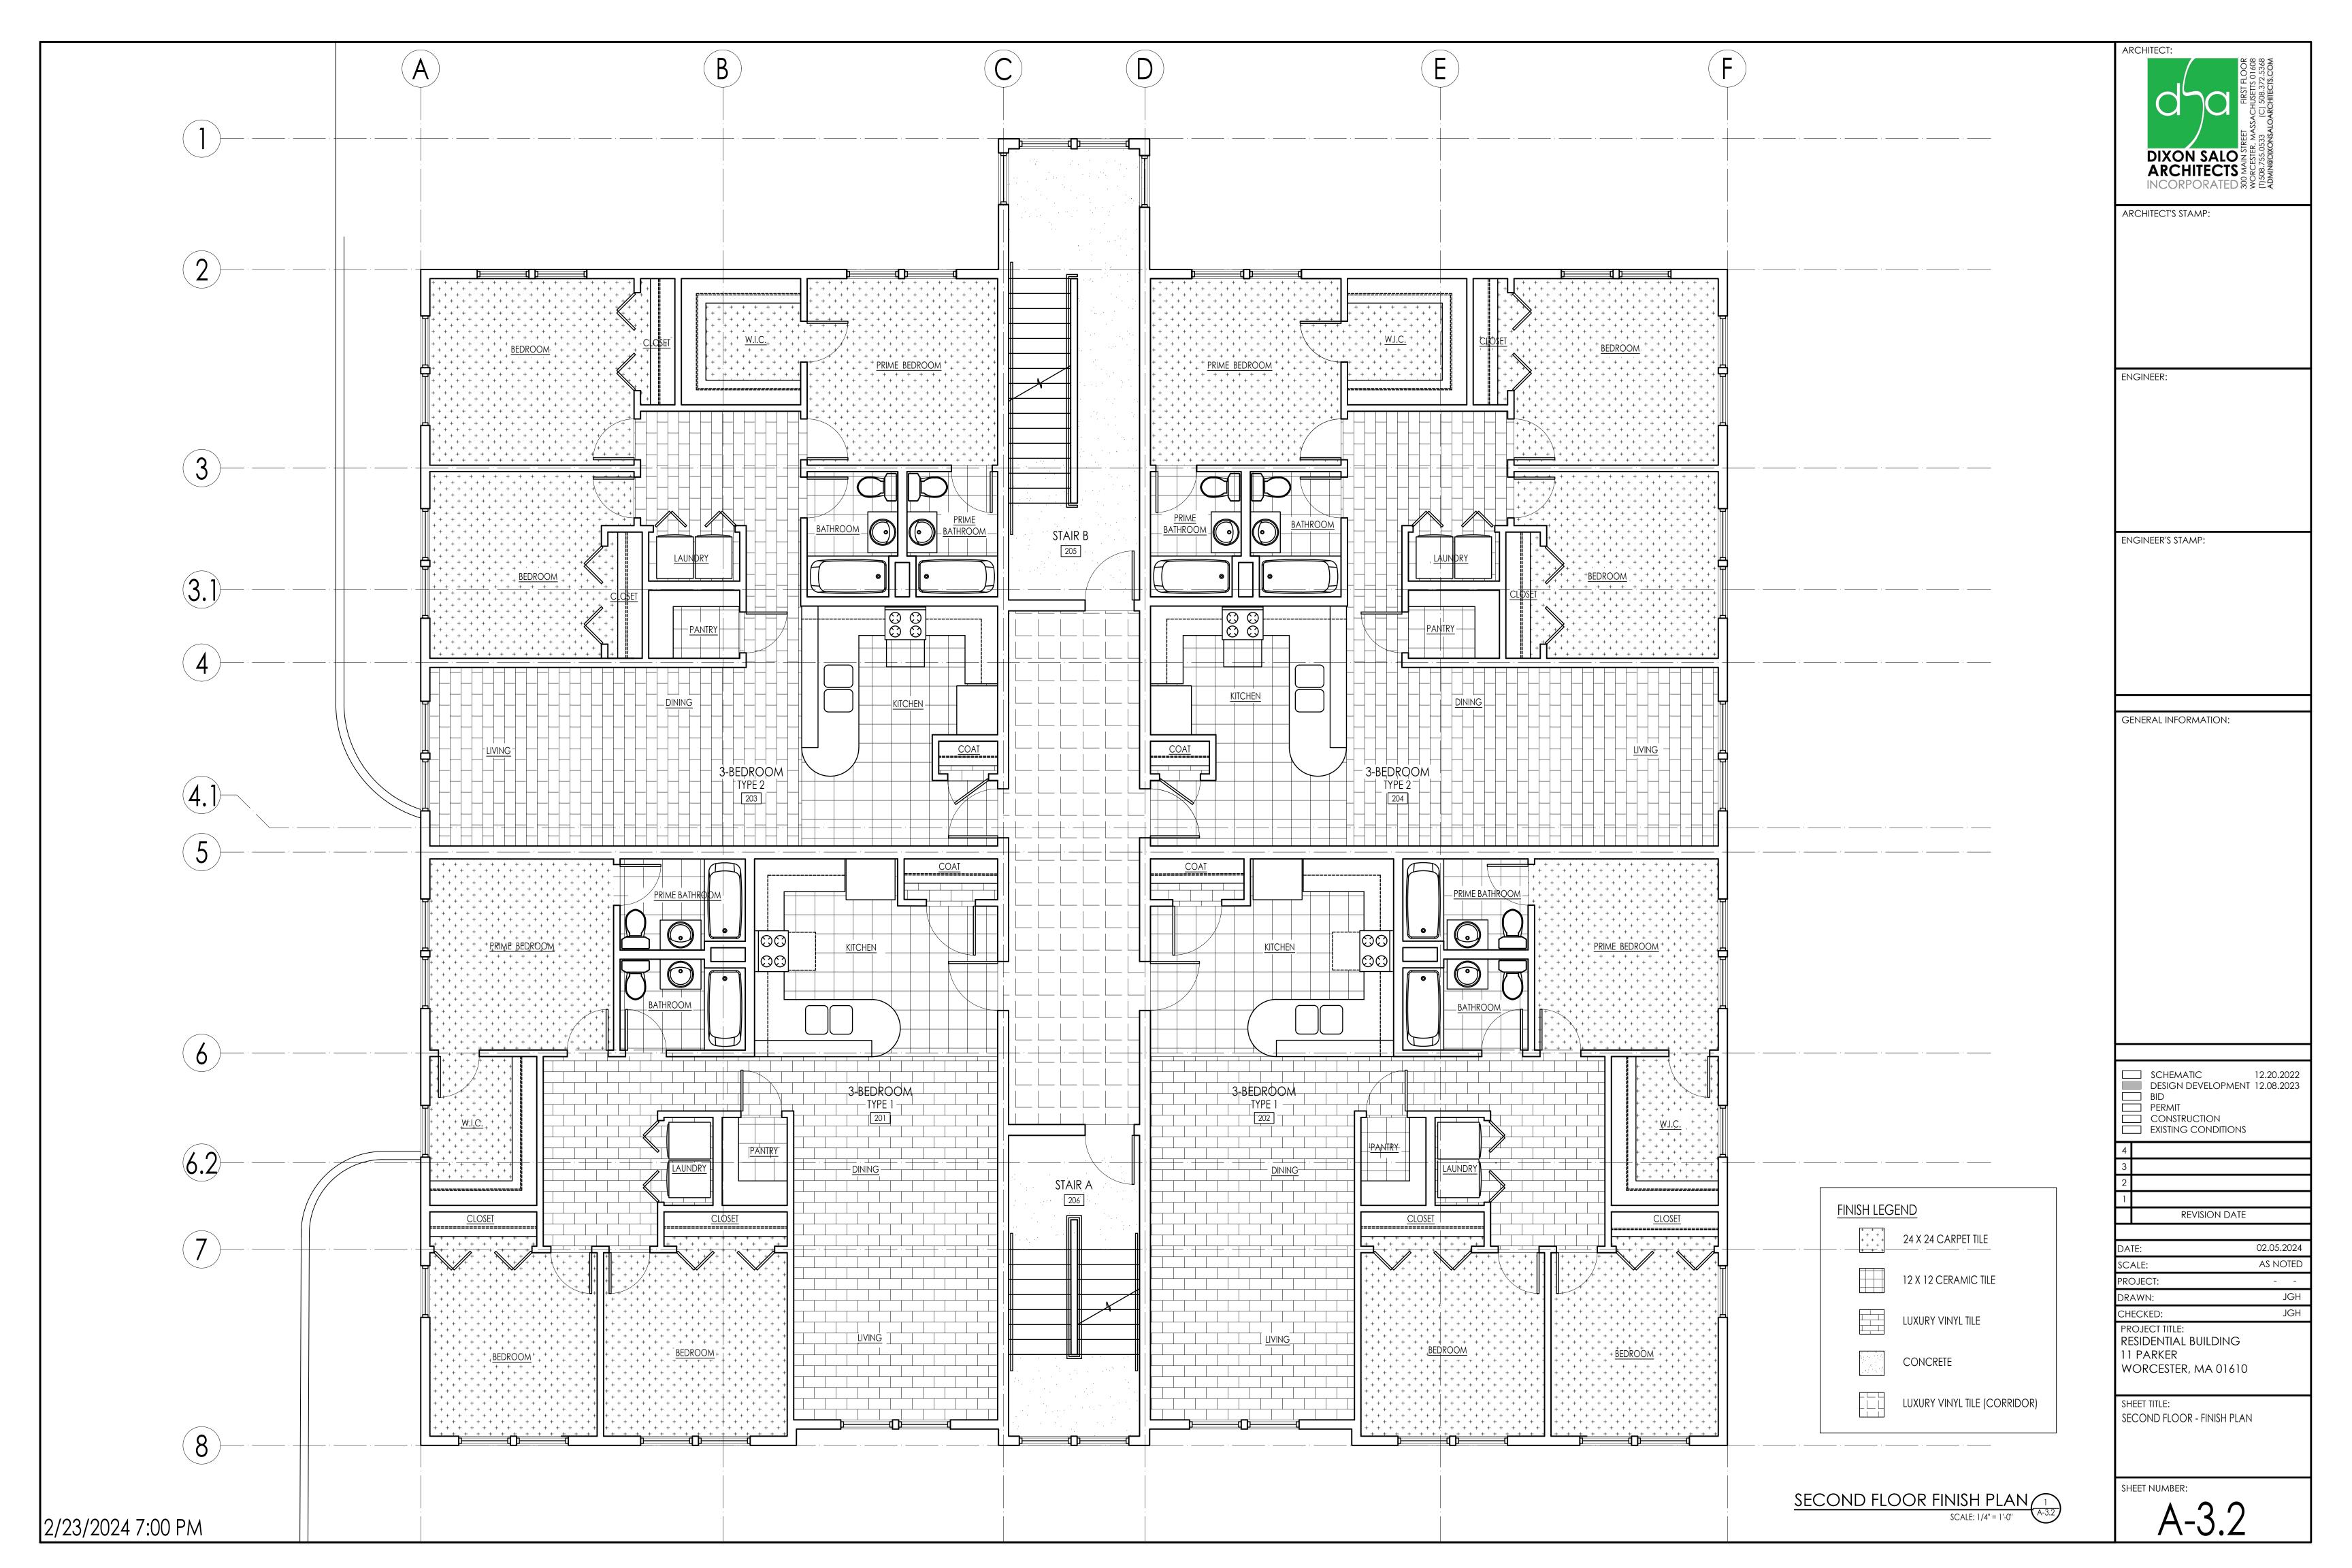

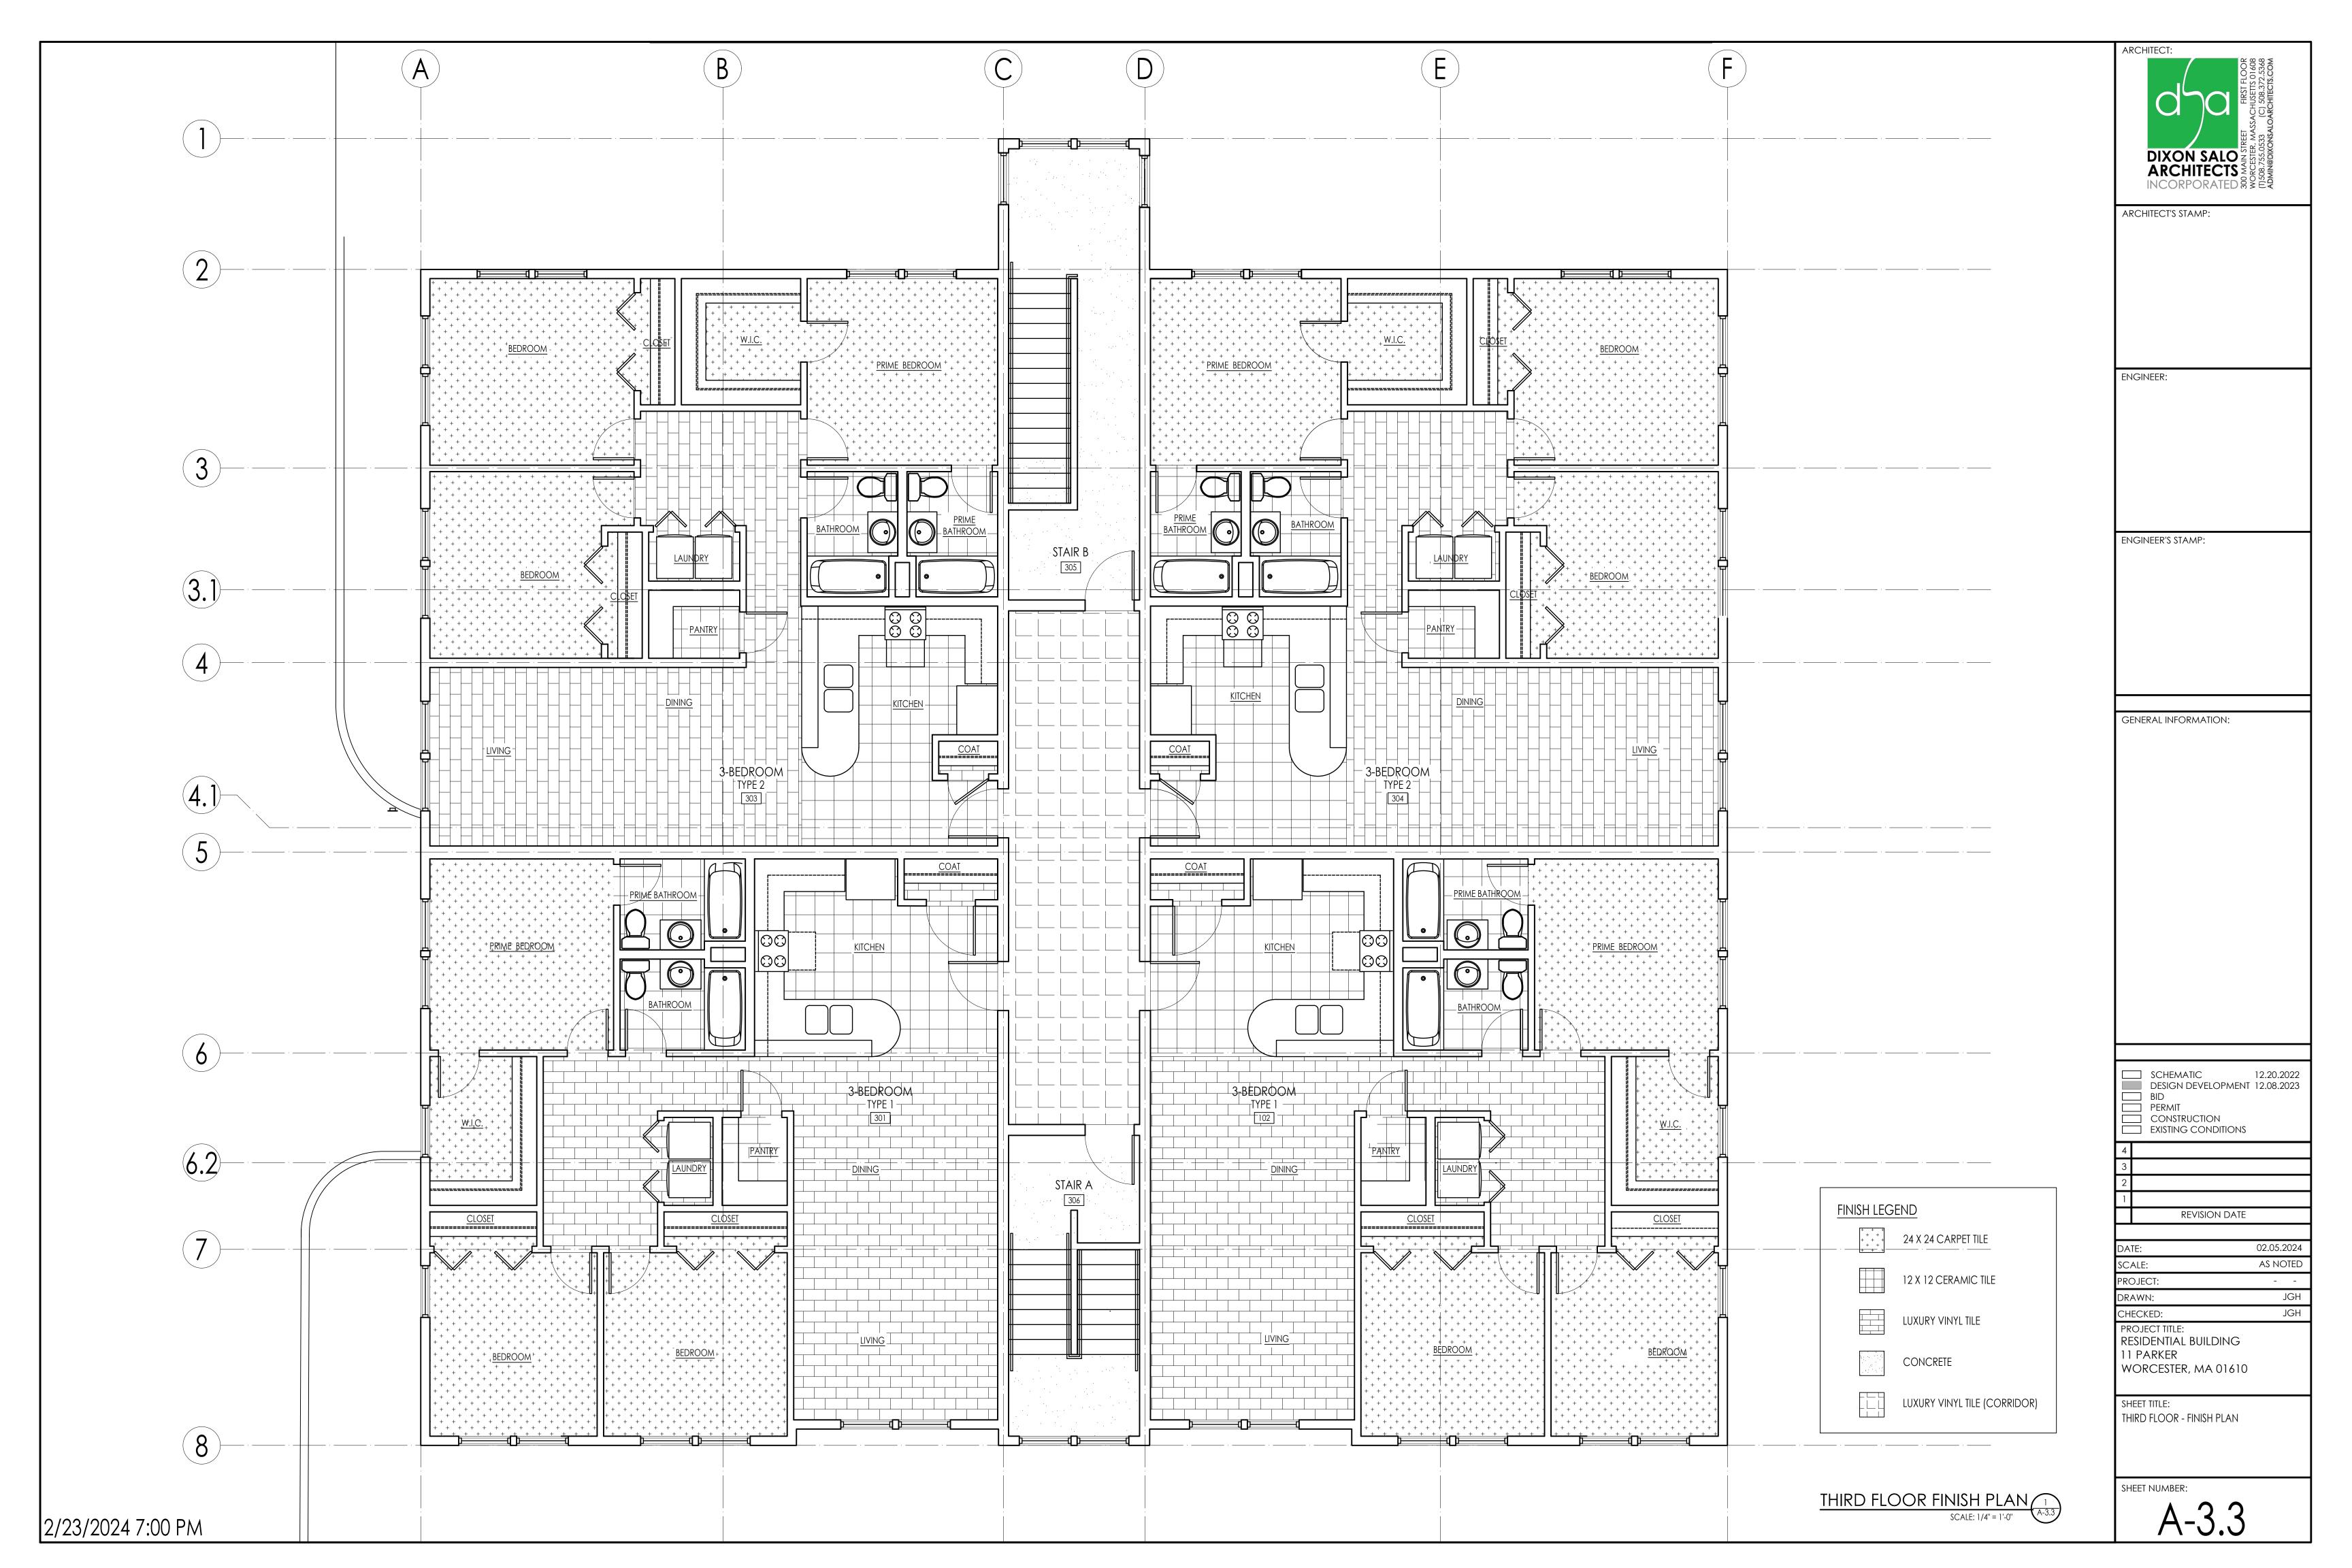










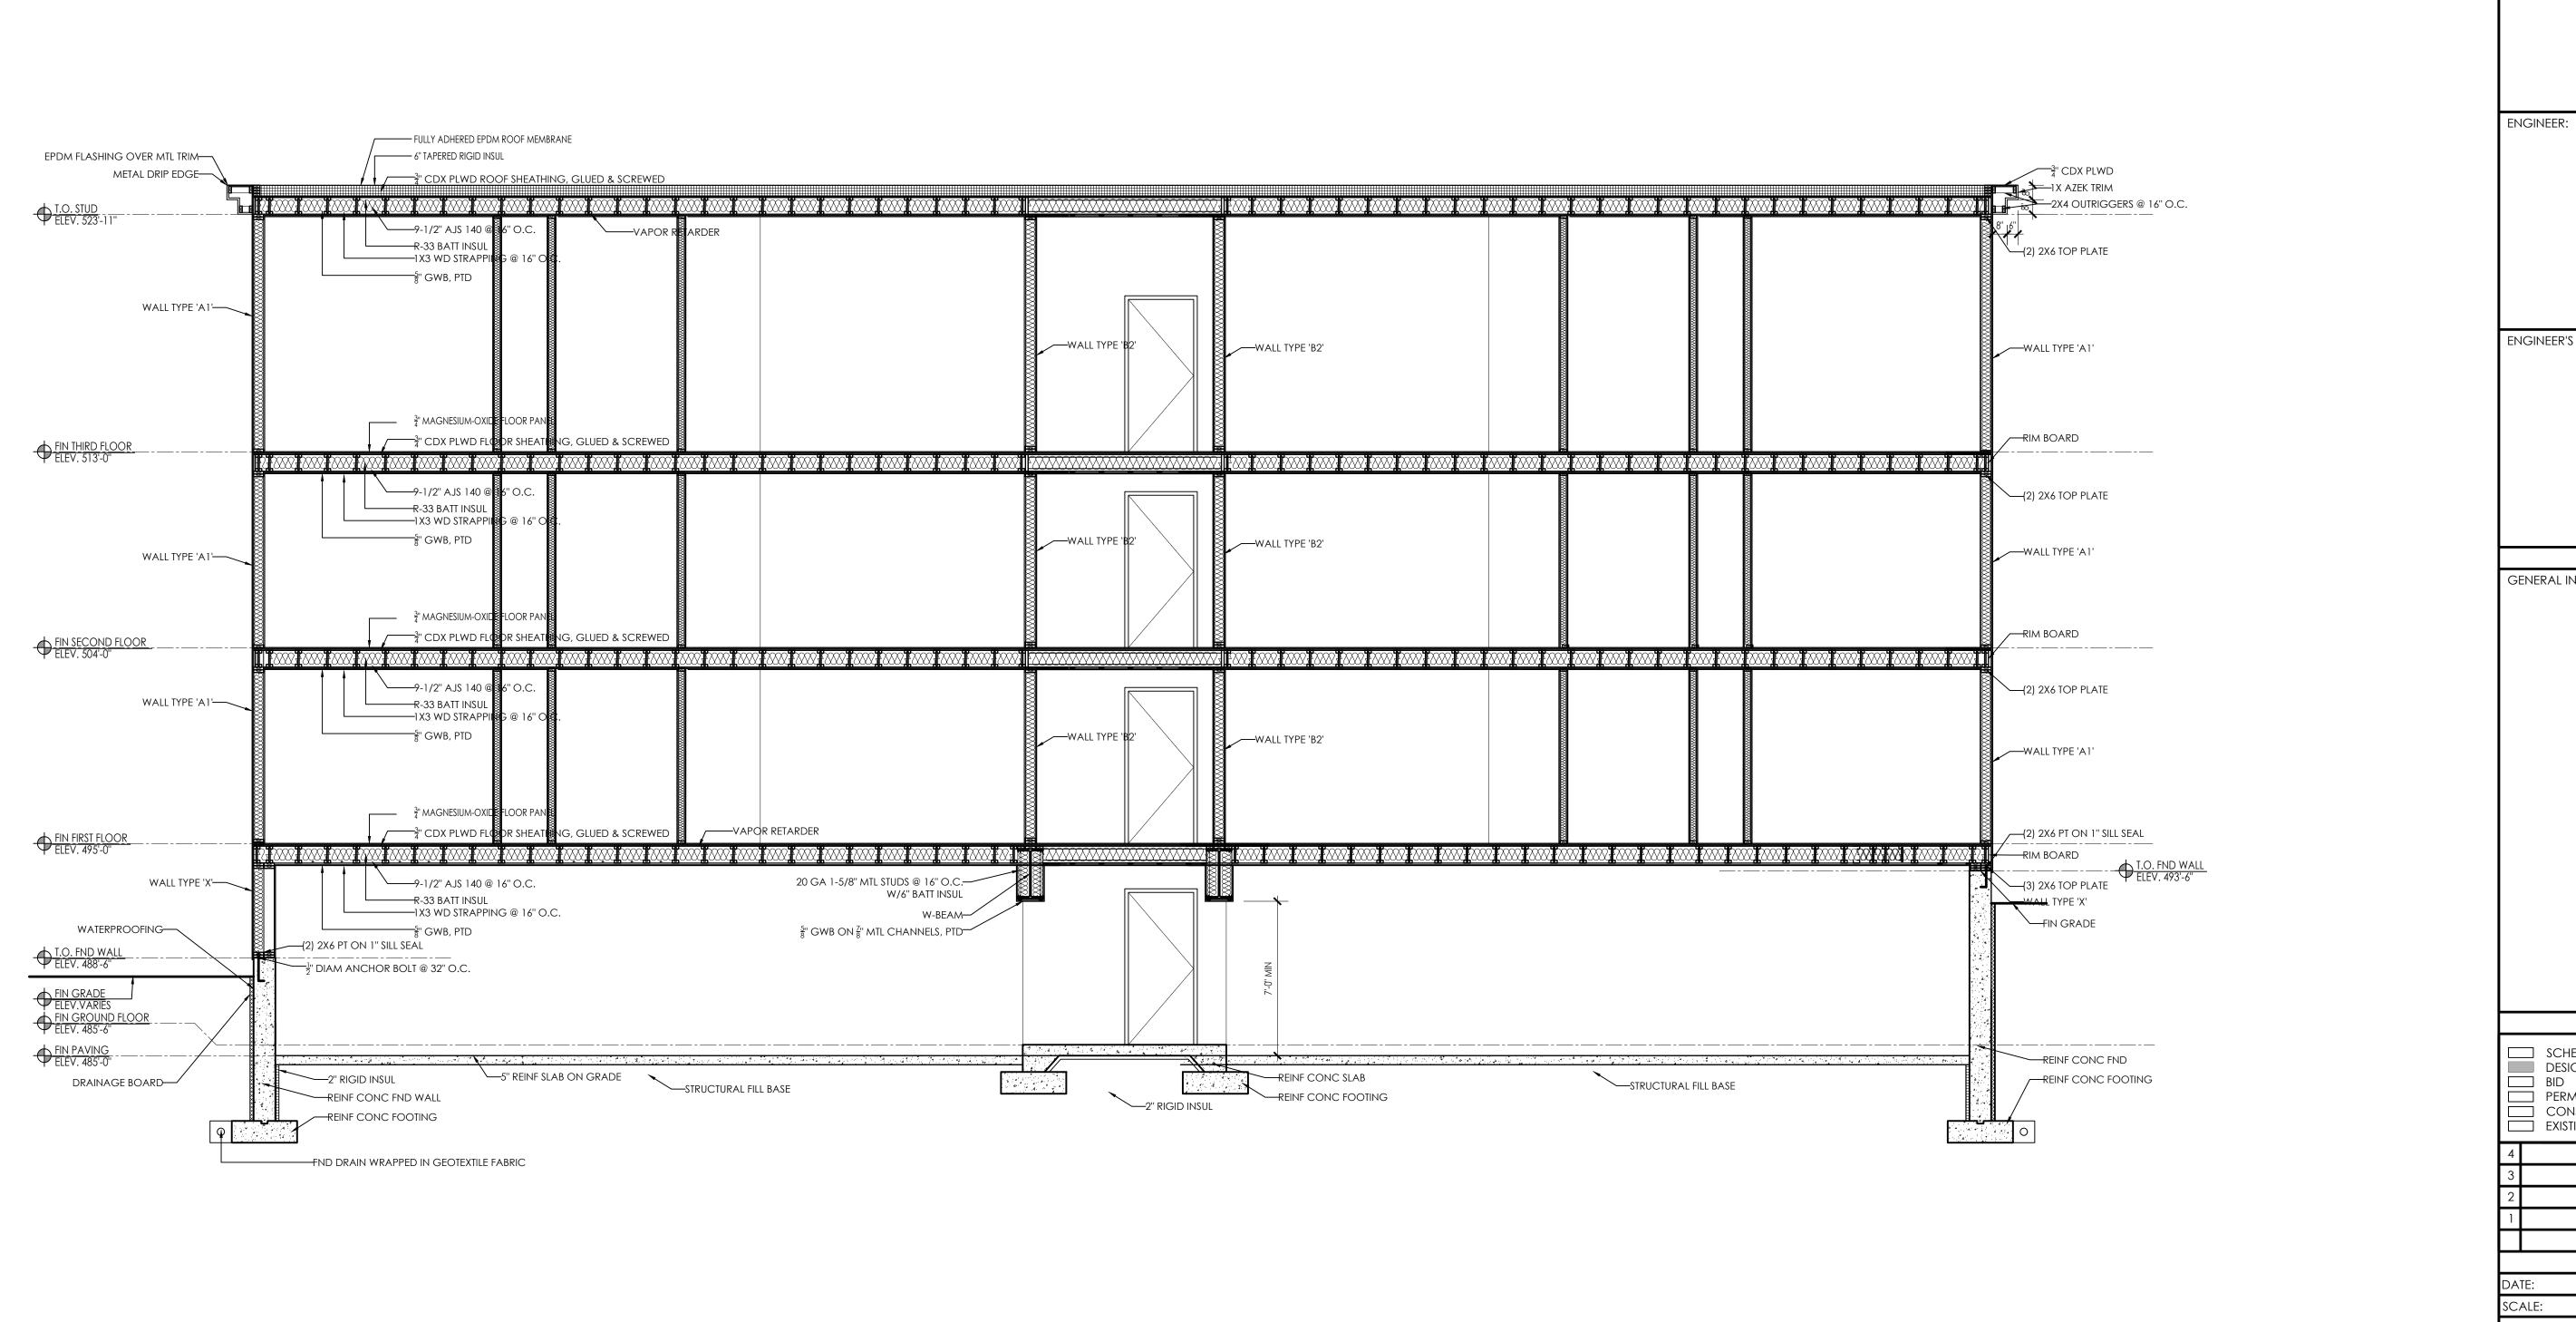

ARCHITECT: DIXON SALO ES NA ARCHITECTS INCORPORATED 8 5 € ₹ ARCHITECT'S STAMP:

ENGINEER'S STAMP:

GENERAL INFORMATION:

SCHEMATIC 12.20.2022
DESIGN DEVELOPMENT 12.08.2023 BID PERMIT CONSTRUCTION
EXISTING CONDITIONS

02.05.2024 AS NOTED PROJECT: - -DRAWN: JGH

REVISION DATE

JGH

CHECKED: PROJECT TITLE: RESIDENTIAL BUILDING 11 PARKER

WORCESTER, MA 01610 SHEET TITLE:


BUILDING SECTION

SHEET NUMBER:

BUILDING SECTION 'A'

SCALE: 1/4" = 1'-0"

A-5.0

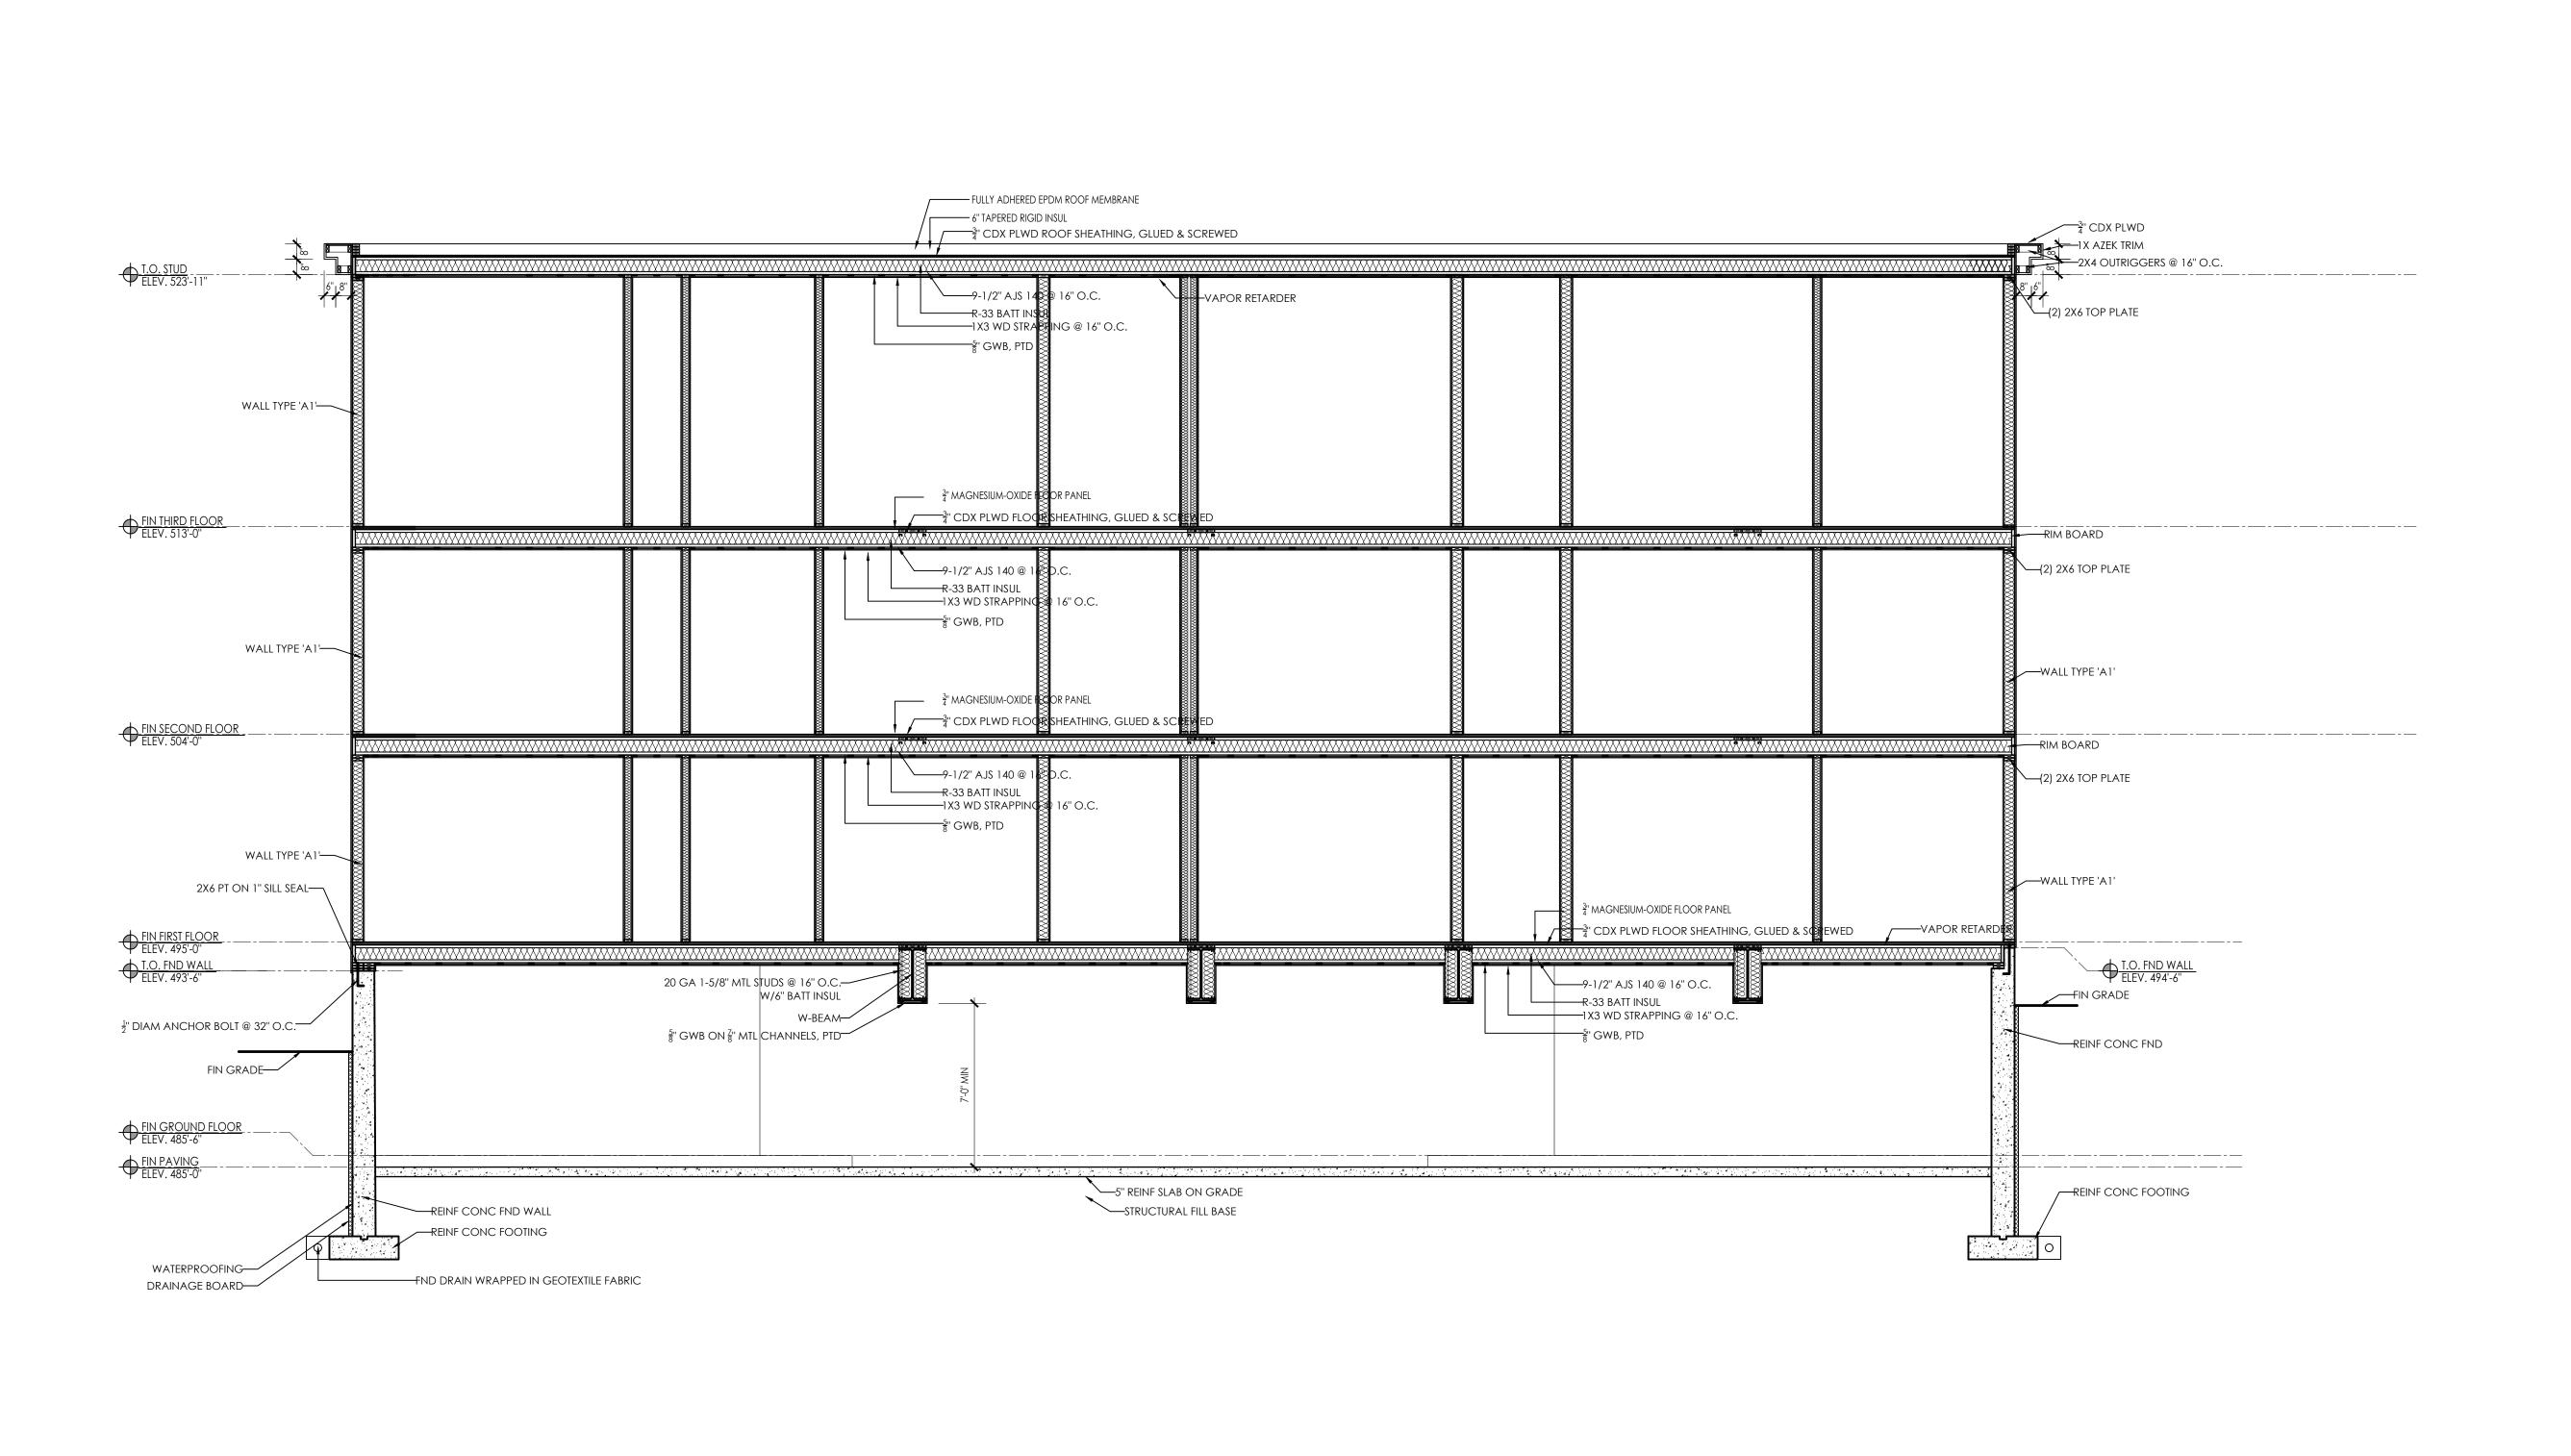

ACHITECT:

SOO MAIN STREET
WORCESTER, MASSACHUSETS 01608
(1)508.755.0533 (C) 508.372.5368
ADMIN@DIXONSALOARCHITECTS.COM

ARCHITECT'S STAMP:

ENGINEER:

ENGINEER'S STAMP:

GENERAL INFORMATION:

SCHEMATIC 12.20.2022
DESIGN DEVELOPMENT 12.08.2023
BID
PERMIT
CONSTRUCTION
EXISTING CONDITIONS

EXISTING CONDITIONS

4

3

2

1

REVISION DATE

DATE: 02.05.2024

SCALE: AS NOTED

PROJECT: -
DRAWN: JGH

JGH

CHECKED:
PROJECT TITLE:
RESIDENTIAL BUILDING
11 PARKER

WORCESTER, MA 01610

SHEET TITLE:
BUILDING SECTION


SHEET NUMBER:


BUILDING SECTION 'B'


SCALE: 1/4" = 1'-0"


A-5.1


A-5.1

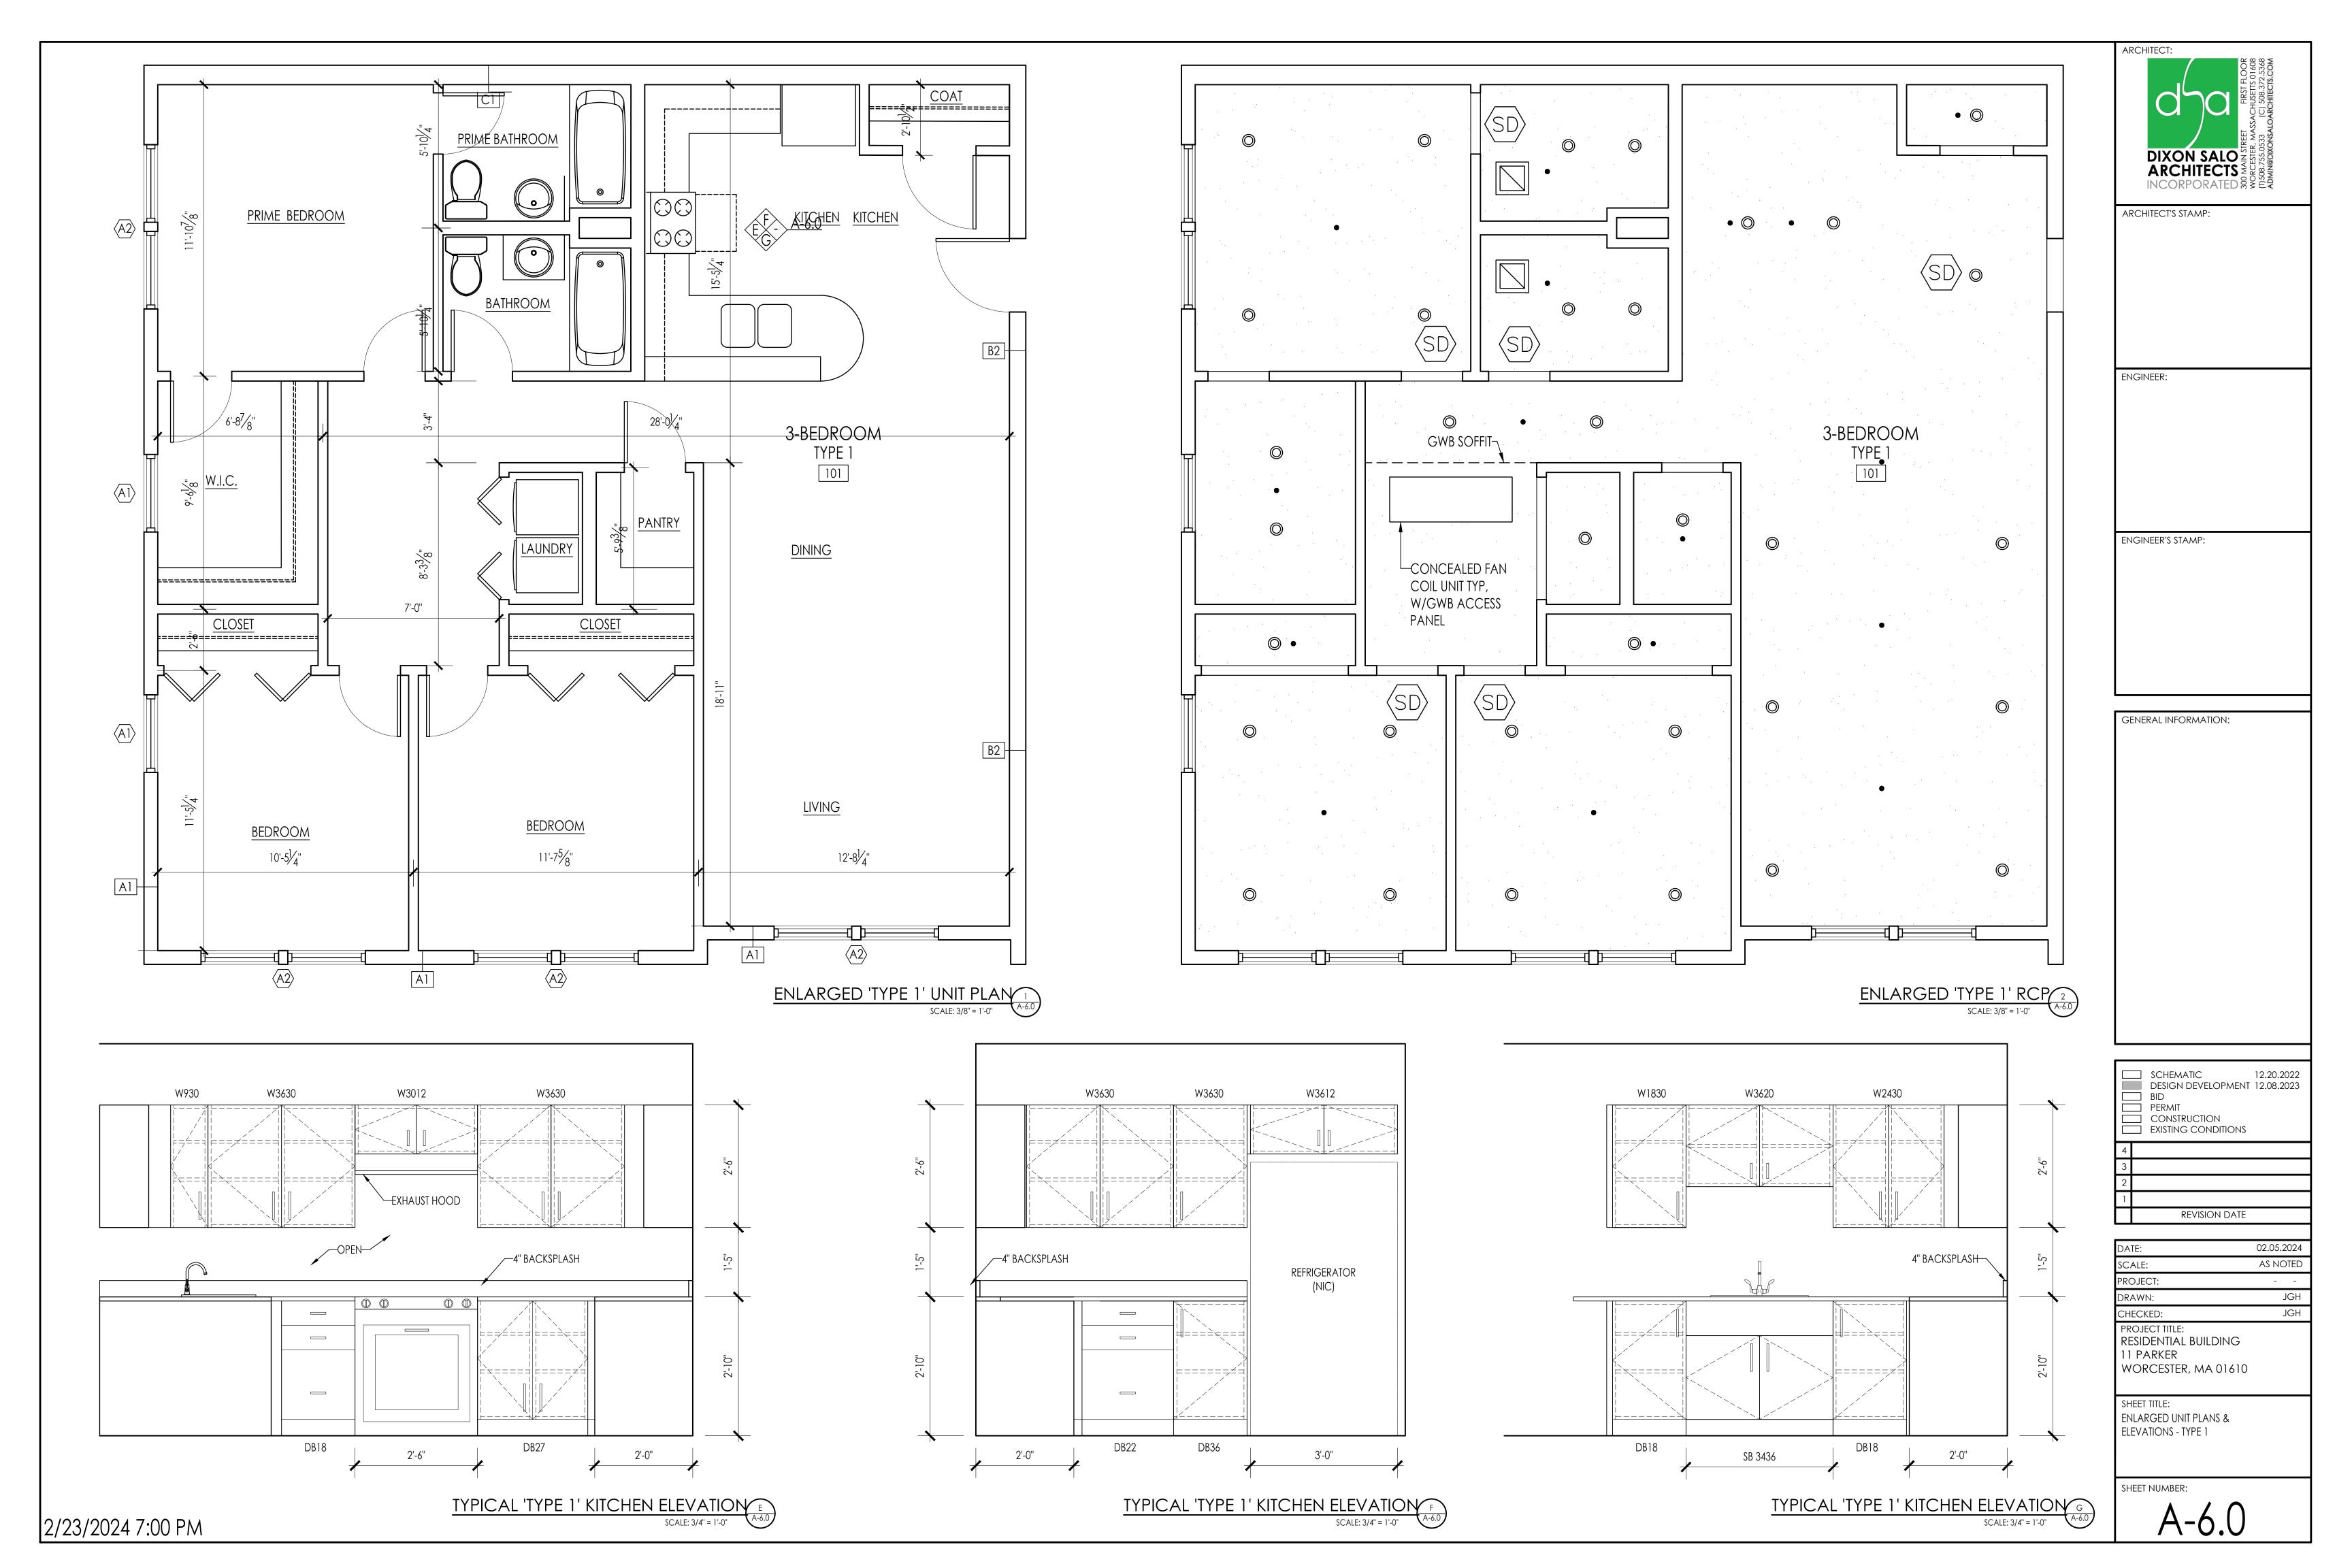


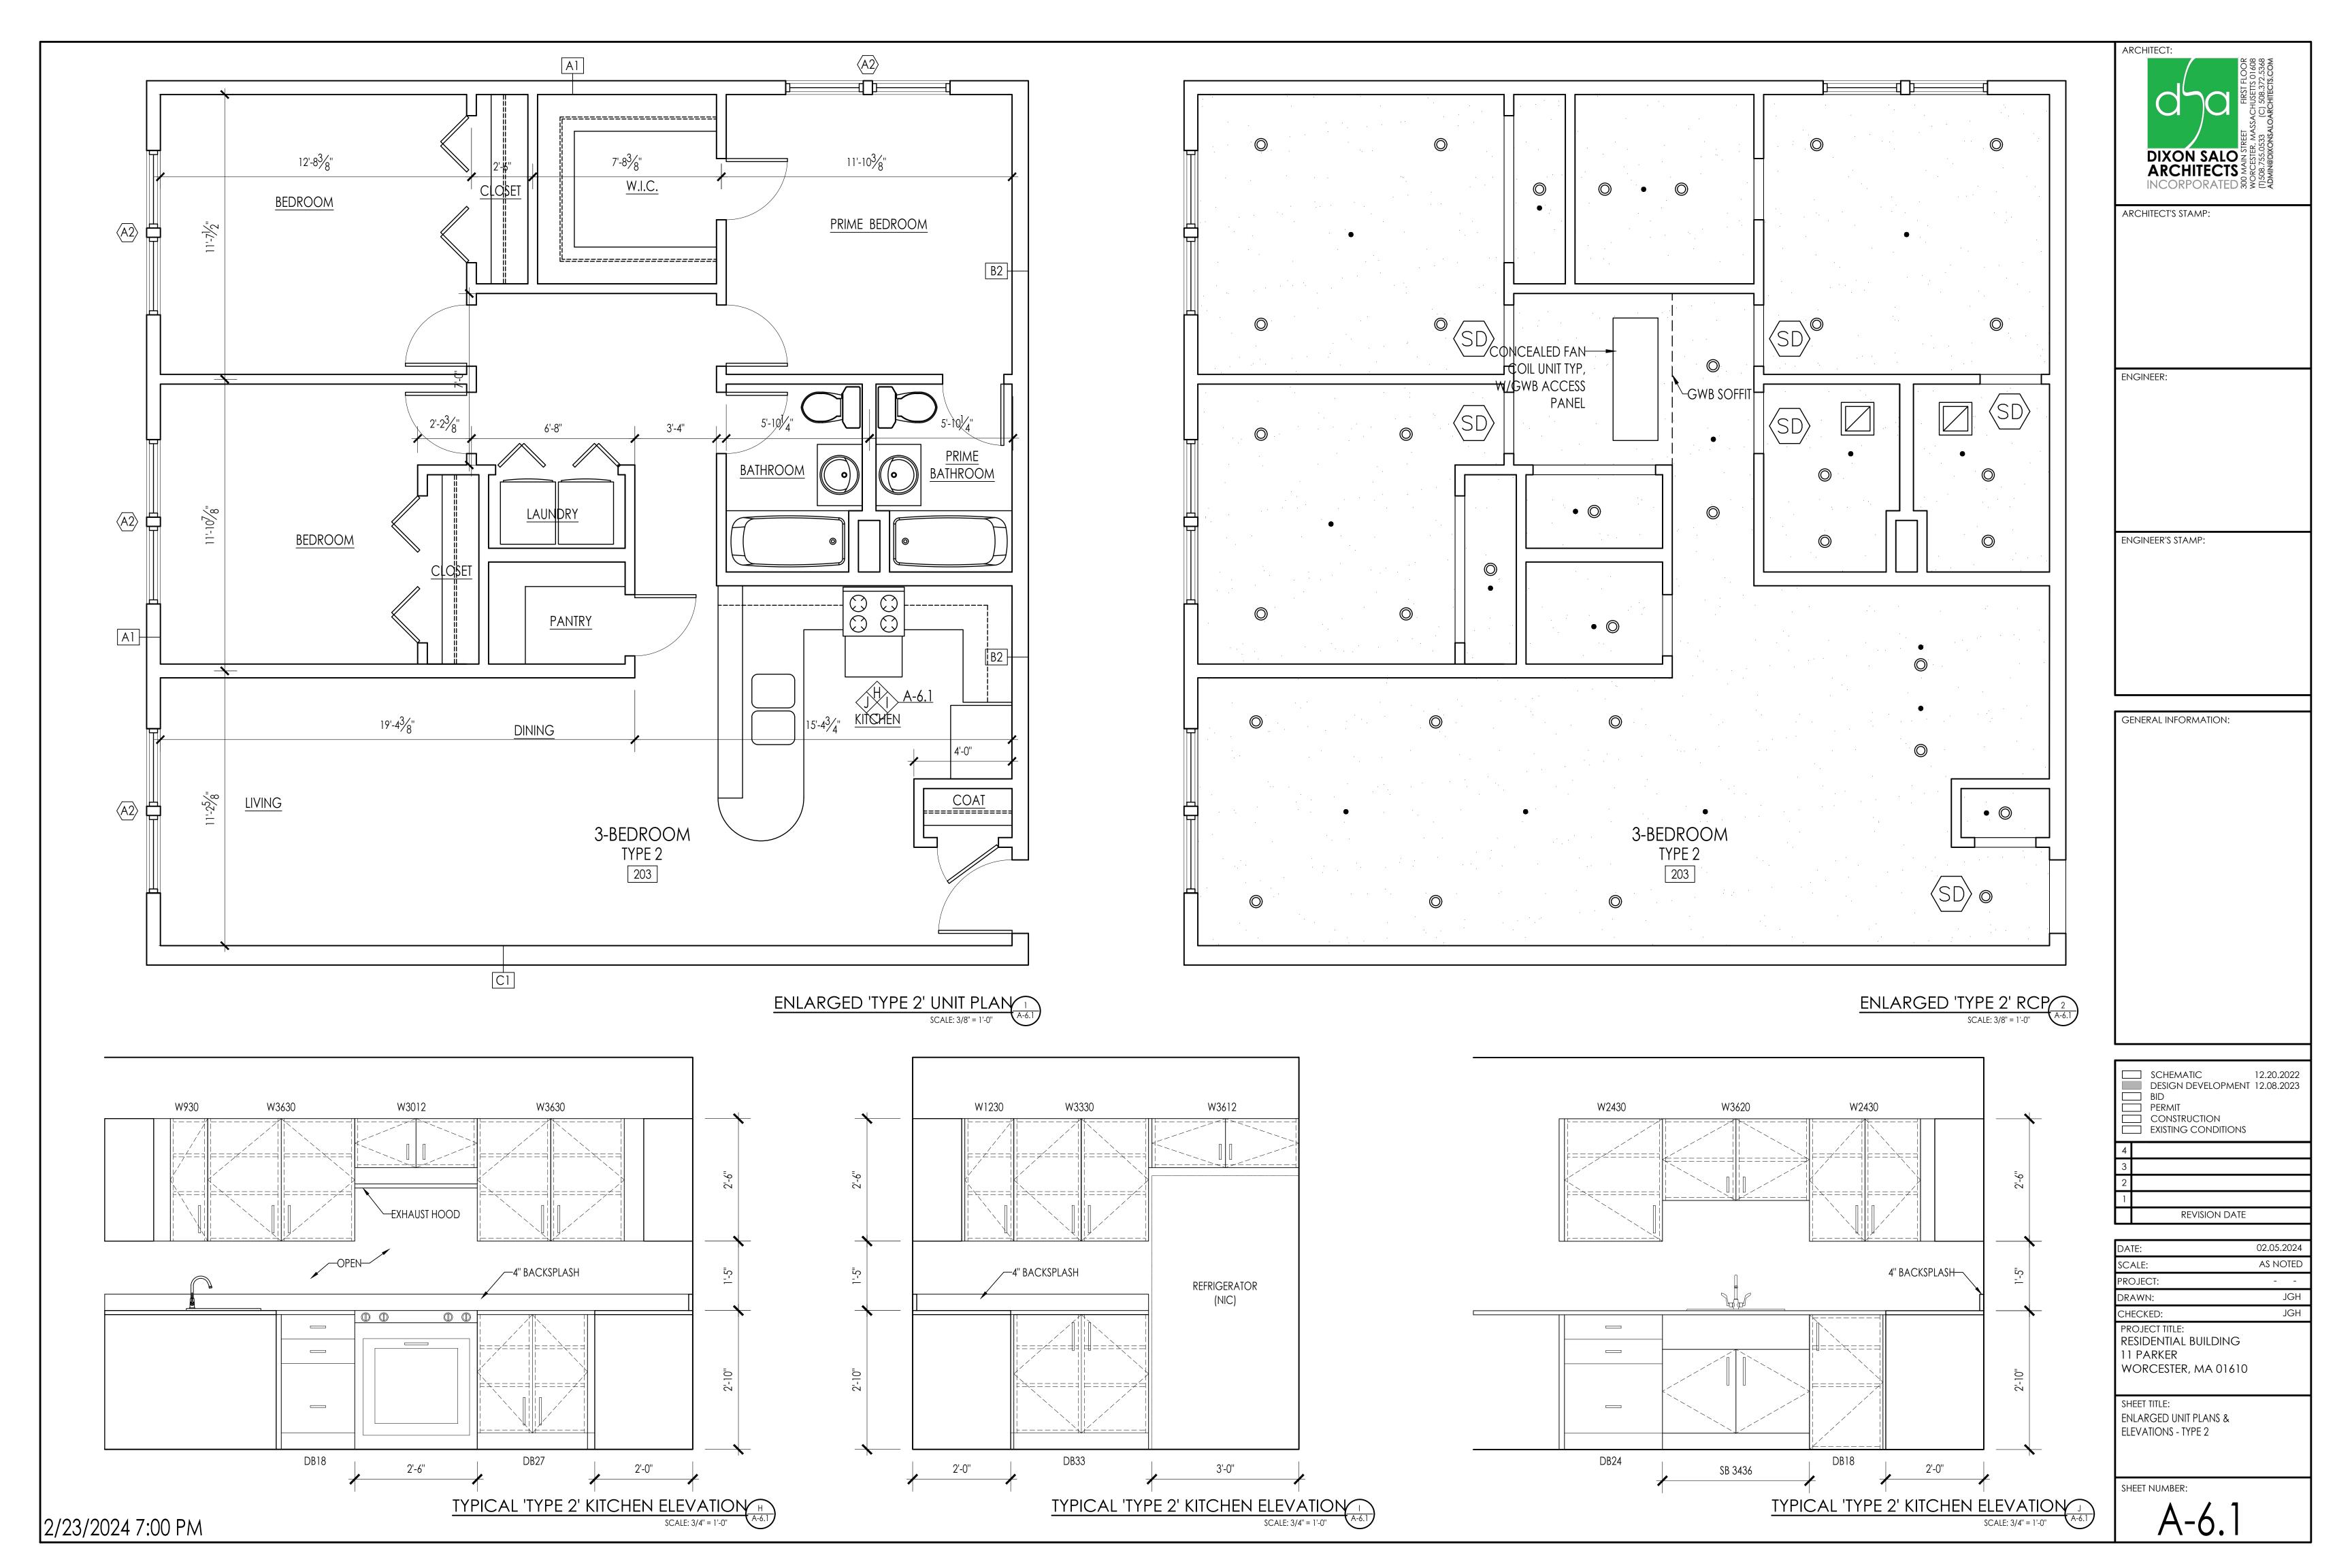


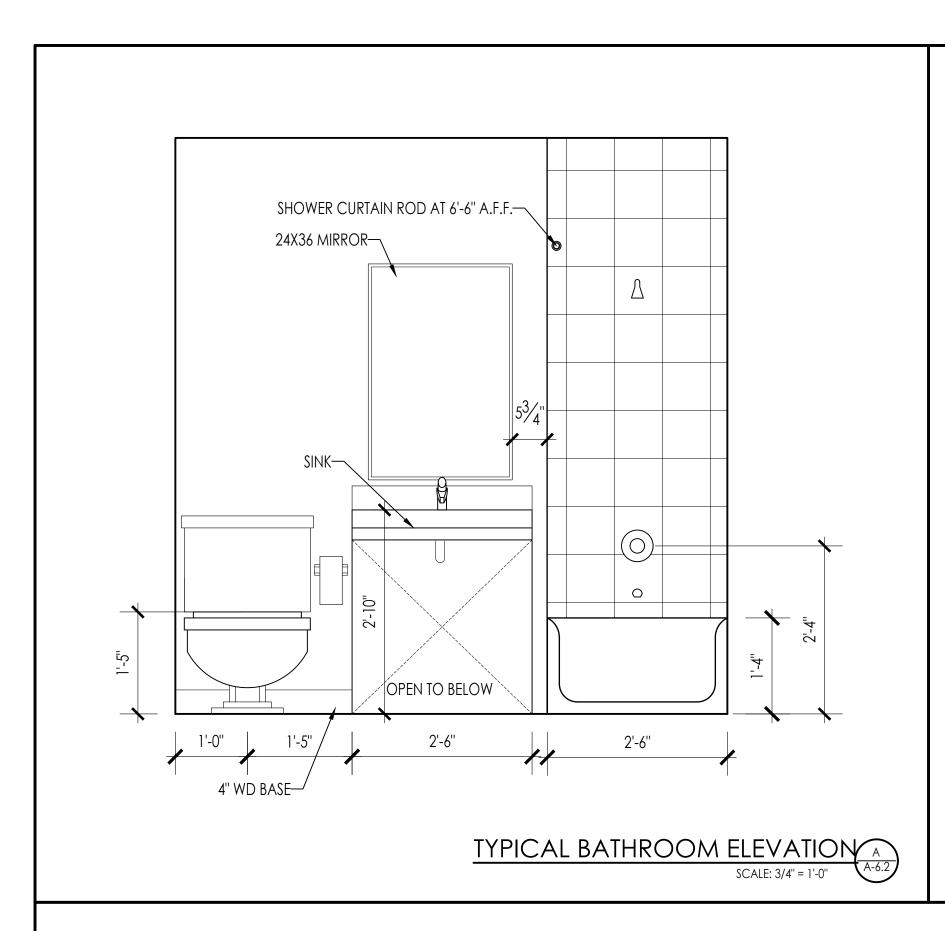

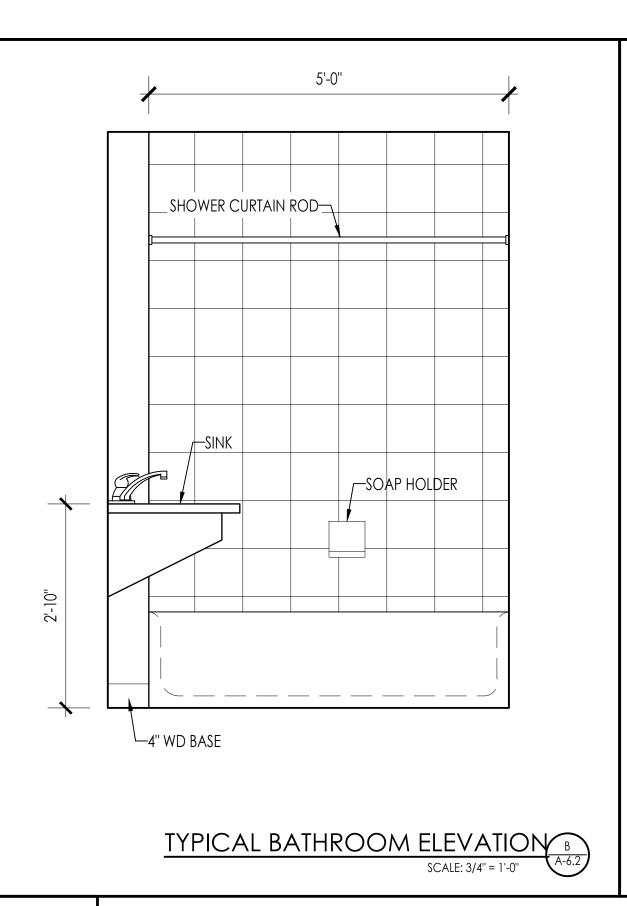


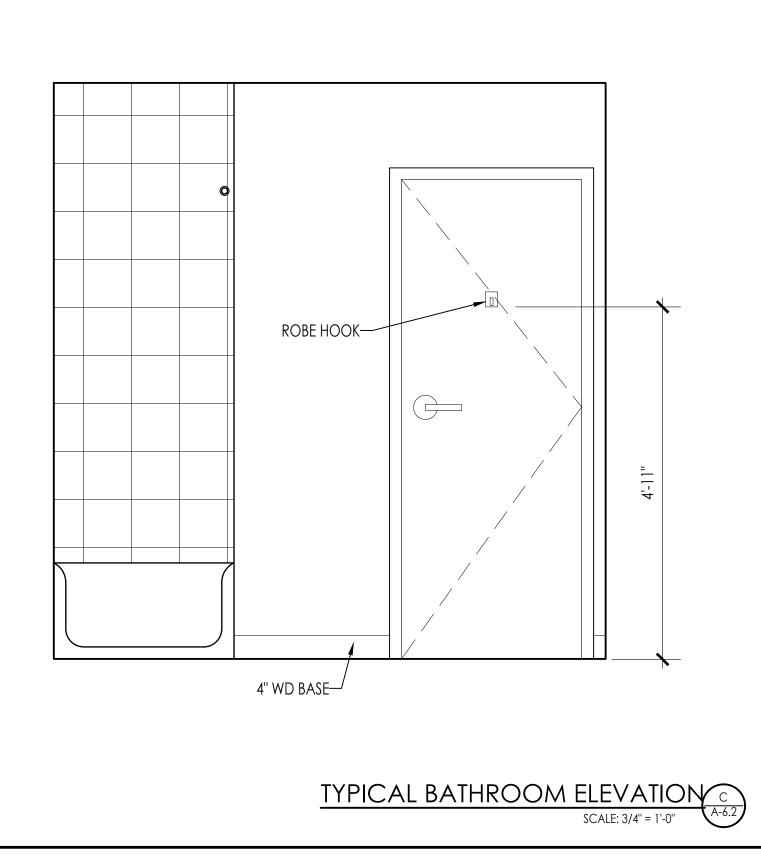


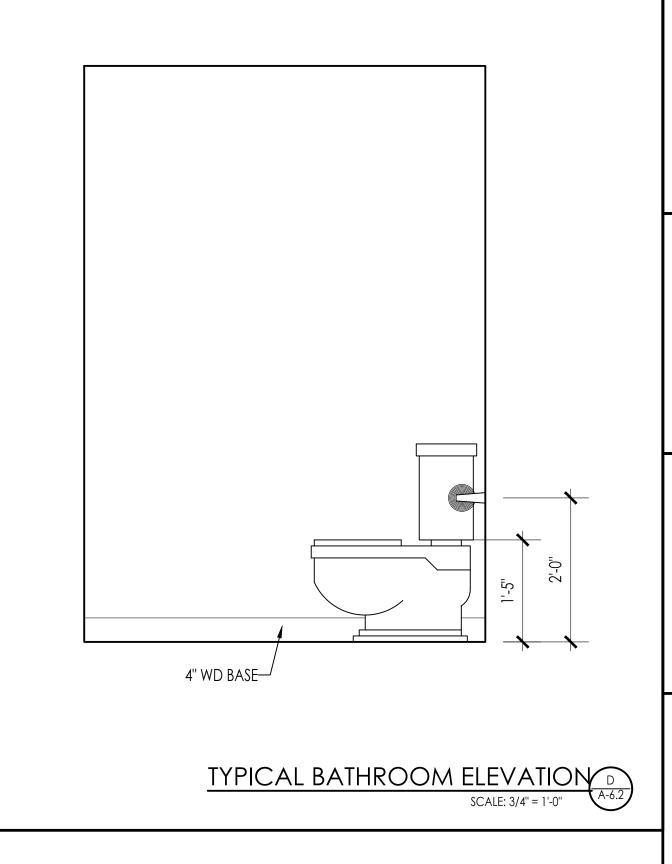

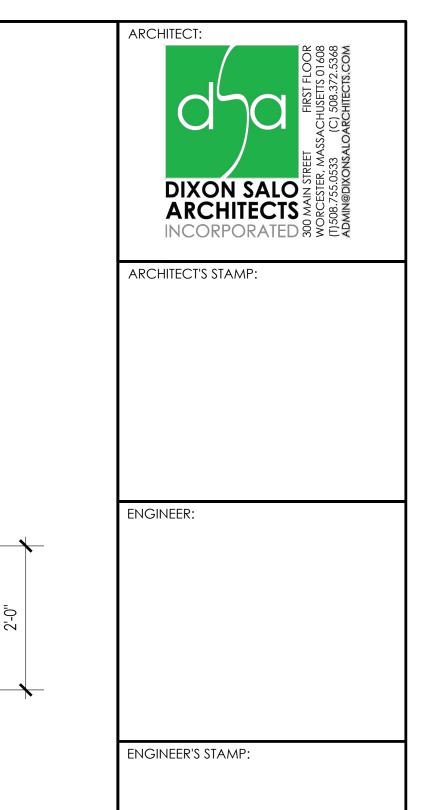

GENERAL INFORMATION:

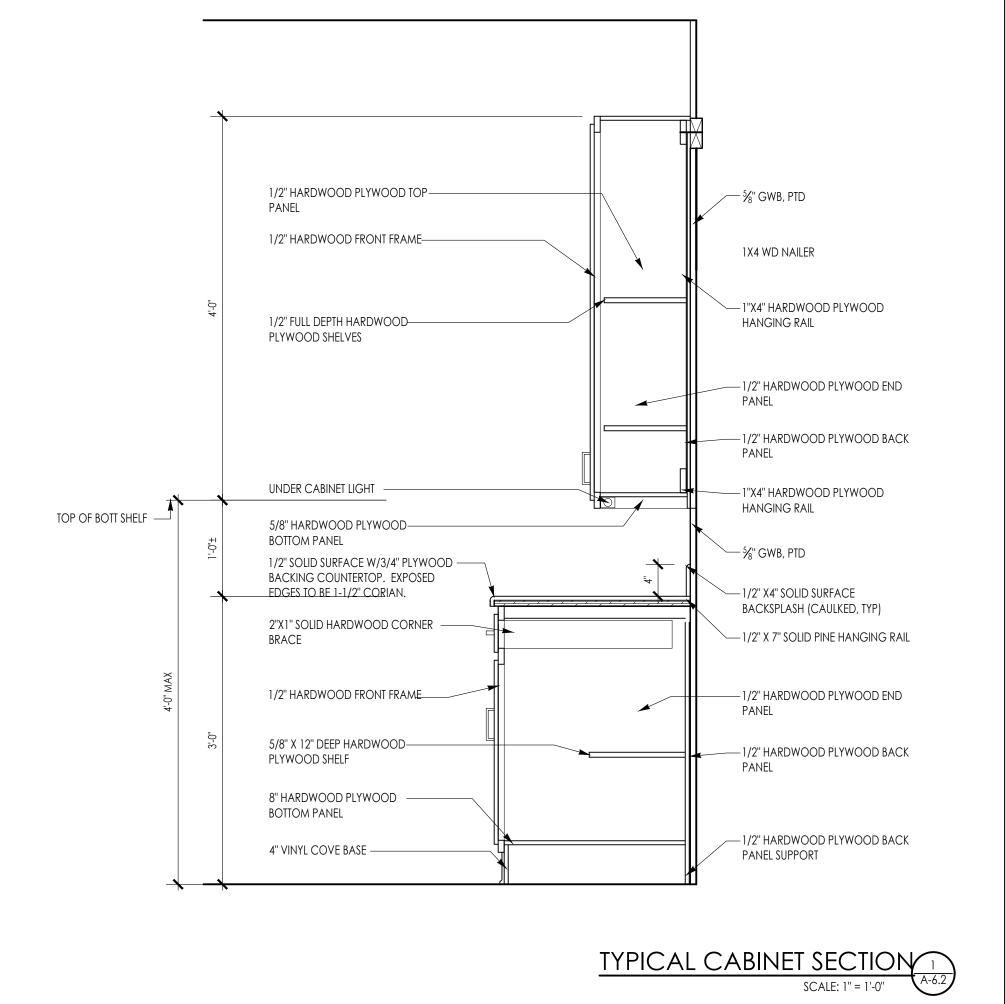

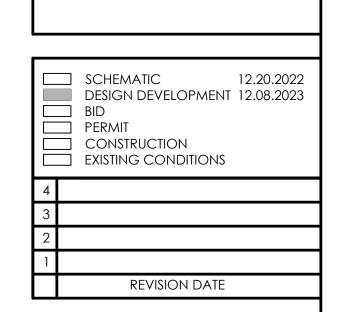

02.05.2024

JGH


JGH


AS NOTED PROJECT: - -DRAWN: CHECKED: PROJECT TITLE: RESIDENTIAL BUILDING 11 PARKER WORCESTER, MA 01610

SHEET TITLE: INTERIOR ELEVATIONS

& TYPICAL DETAILS

SHEET NUMBER:

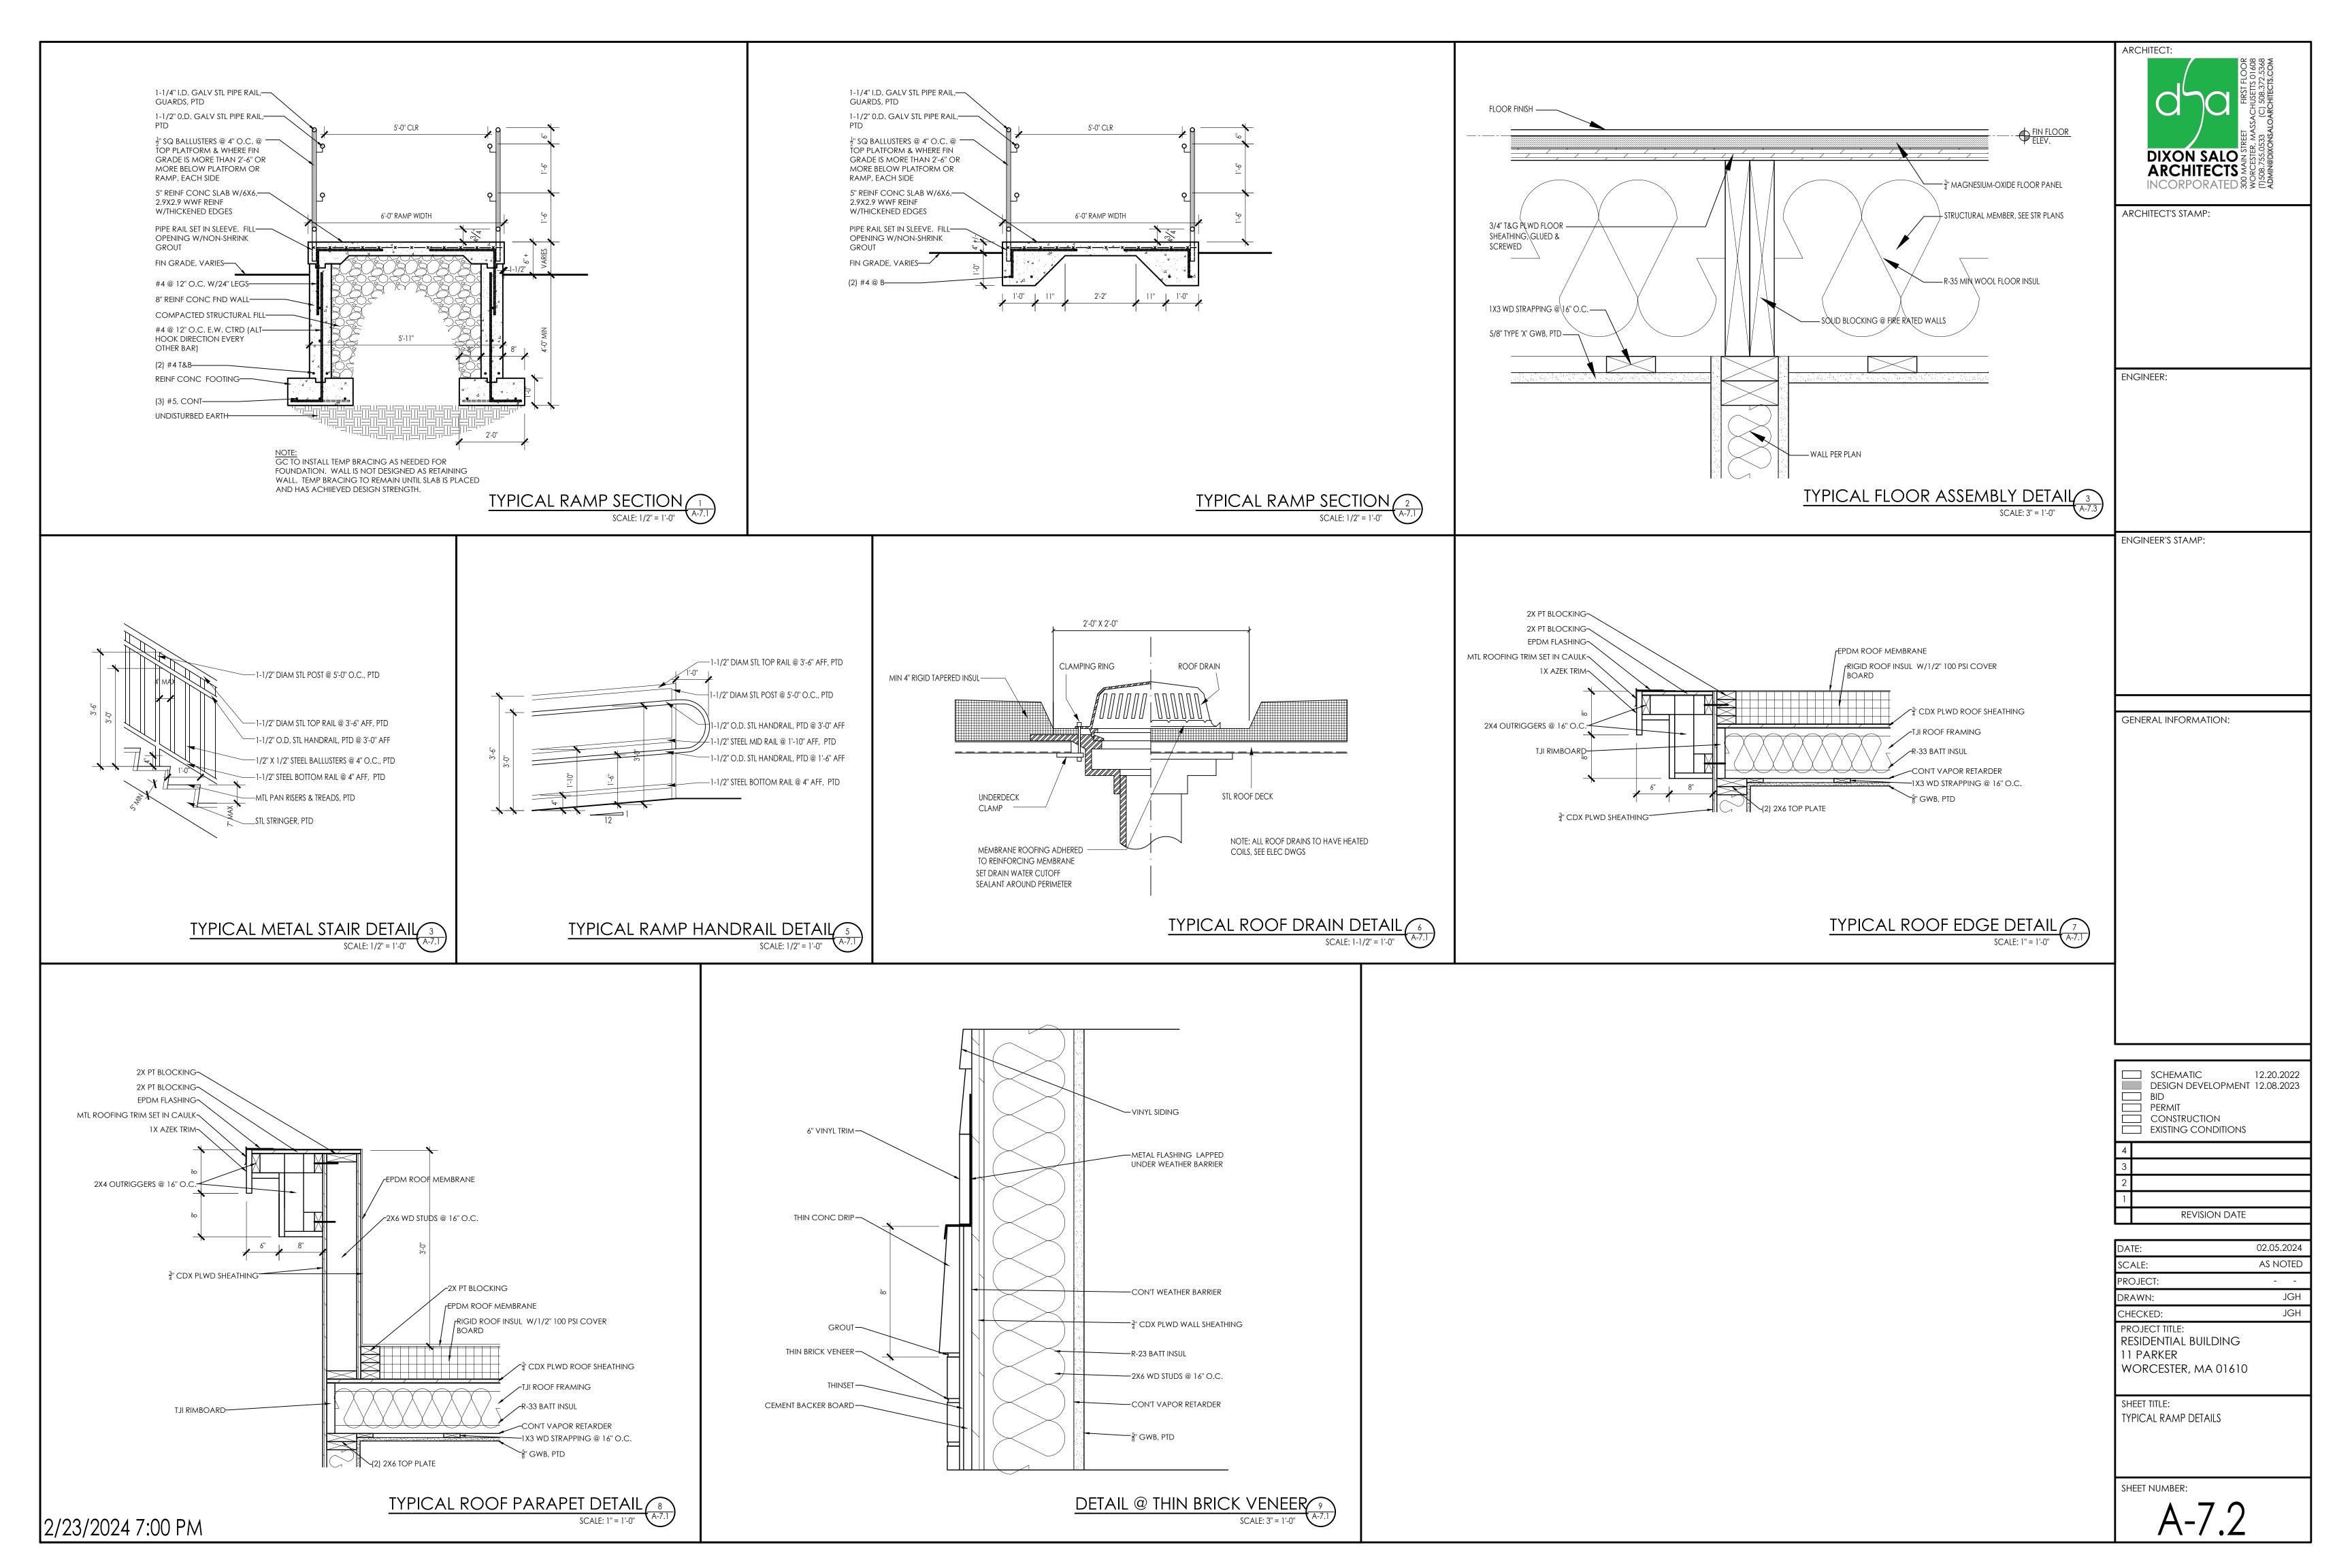

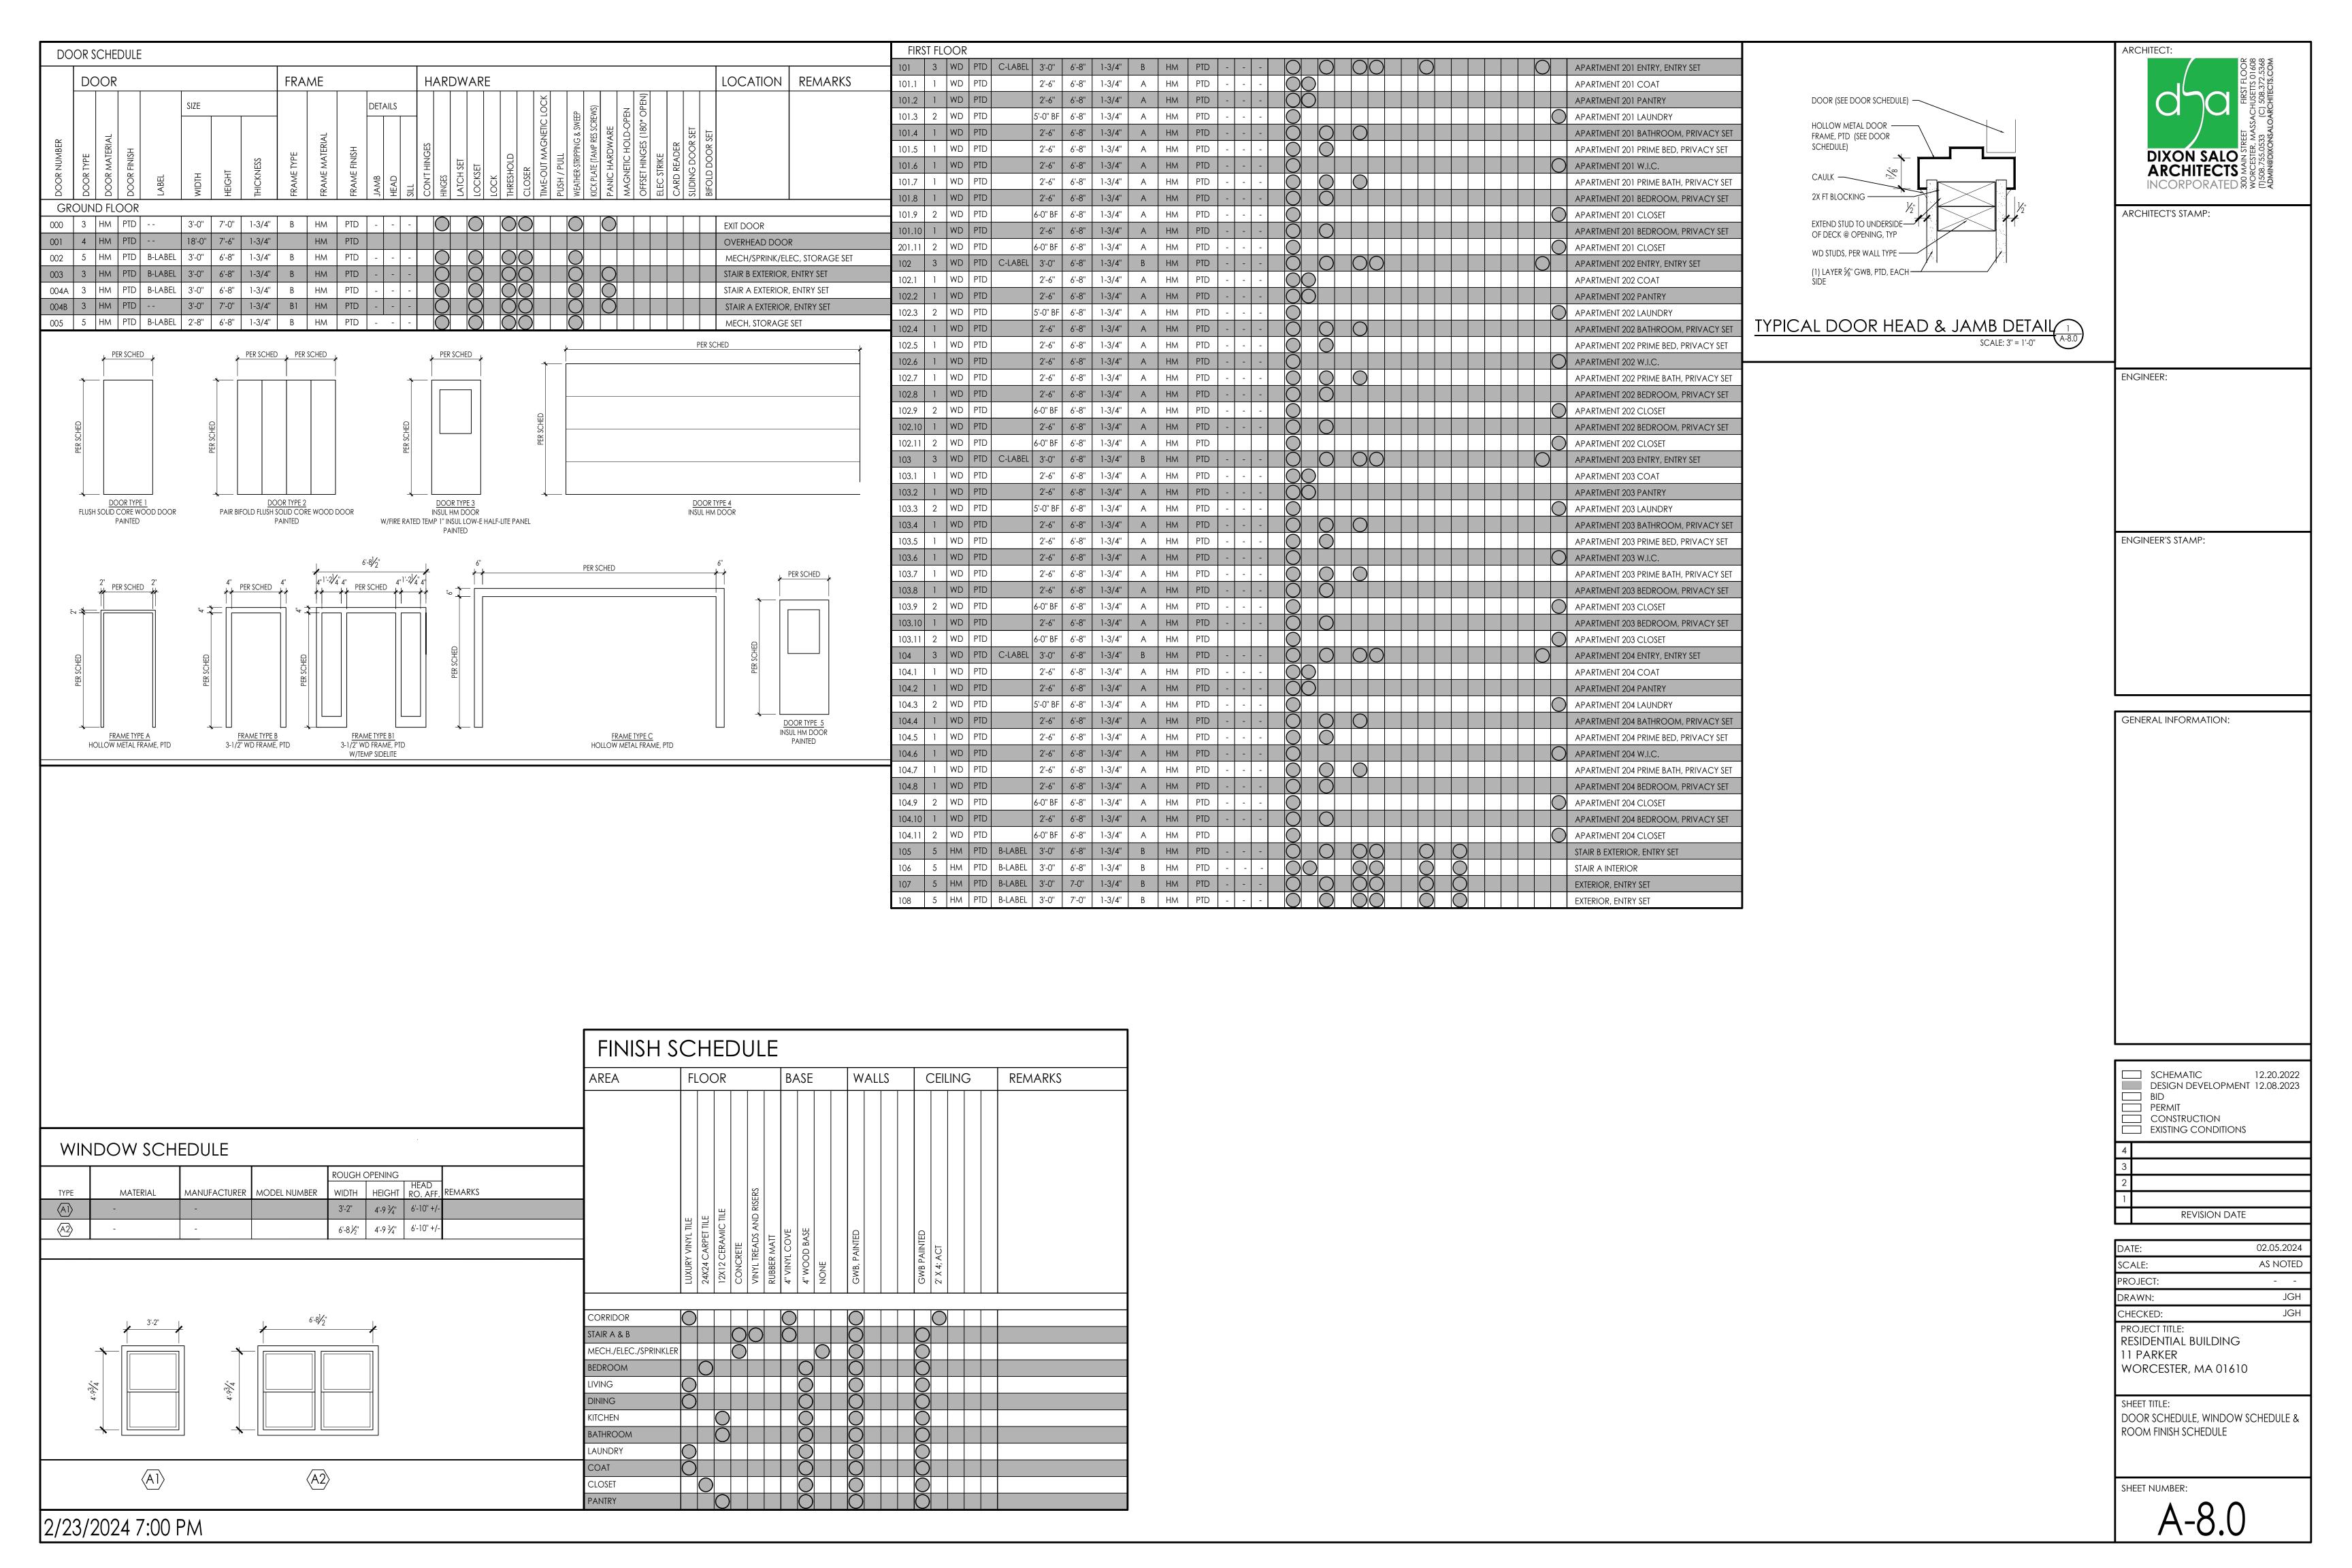

| DOOR SCHEDULE | DOOR SCHEDULE | |
|--|--|--|
| DOOR FRAME HARDWARE | LOCATION REMARKS DOOR | FRAME HARDWARE LOCATION REMARKS |
| DOOR NUMBER DOOR TYPE DOOR MATERIAL LABEL LABEL INGRISH FRAME TYPE FRAME HINSH FRAME HINSH CONT HINGES LATCH SET LOCKSET LOCK THRESHOLD CLOSER TIME-OUT MAGNETIC LOCK PUSH / PULL WEATHER-STRIPPING & SWEEP KICK PLATE (TAMP RES SCREWS) PANIC HARDWARE | OFFSET HINGES (180* OPEN) ELEC STRIKE CARD READER PEEP HOLE BIFOLD DOOR SET DOOR TYPE DOOR TYPE DOOR MATERIAL LABEL | WIDTH HEIGHT HEIGHT HEIGHT FRAME TYPE JAMB (A-6.1) SILL (|
| SECOND FLOOR | THIRD FLOOR | |
| 201 3 WD PTD C-LABEL 3'-0" 6'-8" 1-3/4" B HM PTD | APARTMENT 301 ENTRY, ENTRY SET 301 3 WD PTD C-LABEL | BEL 3'-0" 6'-8" 1-3/4" B HM PTD O O O O APARTMENT 401 ENTRY, ENTRY SET |
| 201.1 1 WD PTD 2'-6" 6'-8" 1-3/4" A HM PTD | APARTMENT 301 COAT 301.1 1 WD PTD | 2'-6" 6'-8" 1-3/4" A HM PTD APARTMENT 401 COAT |
| 201.2 1 WD PTD 2'-6" 6'-8" 1-3/4" A HM PTD | APARTMENT 301 PANTRY 301.2 1 WD PTD | 2'-6" 6'-8" 1-3/4" A HM PTD APARTMENT 401 PANTRY |
| 201.3 2 WD PTD 5'-0" BF 6'-8" 1-3/4" A HM PTD | APARTMENT 301 LAUNDRY 301.3 2 WD PTD | 5'-0" BF 6'-8" 1-3/4" A HM PTD O APARTMENT 401 LAUNDRY |
| 201.4 1 WD PTD 2'-6" 6'-8" 1-3/4" A HM PTD O O O | APARTMENT 301 BATHROOM, PRIVACY SET 301.4 1 WD PTD | 2'-6" 6'-8" 1-3/4" A HM PTD O O O APARTMENT 401 BATHROOM, PRIVACY |
| 201.5 1 WD PTD 2'-6" 6'-8" 1-3/4" A HM PTD | APARTMENT 301 PRIME BED, PRIVACY SET 301.5 1 WD PTD | 2'-6" 6'-8" 1-3/4" A HM PTD O O APARTMENT 401 PRIME BED, PRIVACY SI |
| 201.6 1 WD PTD 2'-6" 6'-8" 1-3/4" A HM PTD | APARTMENT 301 W.I.C. 301.6 1 WD PTD | 2'-6" 6'-8" 1-3/4" A HM PTD O APARTMENT 401 W.I.C. |
| 201.7 1 WD PTD 2'-6" 6'-8" 1-3/4" A HM PTD O O O | APARTMENT 301 PRIME BATH, PRIVACY SET 301.7 1 WD PTD | 2'-6" 6'-8" 1-3/4" A HM PTD O O O A PRIVACY S |
| 201.8 1 WD PTD 2'-6" 6'-8" 1-3/4" A HM PTD - - - C C C C C C | APARTMENT 301 BEDROOM, PRIVACY SET 301.8 1 WD PTD APARTMENT 301 CLOSET 301.9 2 WD PTD | 2'-6" 6'-8" 1-3/4" A HM PTD O O APARTMENT 401 BEDROOM, PRIVACY S 6-0" BF 6'-8" 1-3/4" A HM PTD O APARTMENT 401 CLOSET |
| | | |
| 201.10 1 WD PTD 2'-6" 6'-8" 1-3/4" A HM PTD | APARTMENT 301 BEDROOM, PRIVACY SET 301.10 1 WD PTD APARTMENT 301 CLOSET 301.11 2 WD PTD | 2'-6" 6'-8" 1-3/4" A HM PTD O O APARTMENT 401 BEDROOM, PRIVACY S 6-0" BF 6'-8" 1-3/4" A HM PTD O APARTMENT 401 CLOSET |
| 201.11 2 WD PTD C-LABEL 3'-0" 6'-8" 1-3/4" B HM PTD O O O | APARTMENT 302 ENTRY, ENTRY SET 302 3 WD PTD C-LABEL | |
| 202.1 1 WD PTD 2'-6" 6'-8" 1-3/4" A HM PTD | APARTMENT 302 COAT 302.1 1 WD PTD | 2'-6" 6'-8" 1-3/4" A HM PTD APARTMENT 402 COAT |
| 202.2 1 WD PTD 2'-6" 6'-8" 1-3/4" A HM PTD | APARTMENT 302 PANTRY 302.2 1 WD PTD | 2'-6" 6'-8" 1-3/4" A HM PTD APARTMENT 402 PANTRY |
| 202.3 2 WD PTD 5'-0" BF 6'-8" 1-3/4" A HM PTD | APARTMENT 302 LAUNDRY 302.3 2 WD PTD | 5'-0" BF 6'-8" 1-3/4" A HM PTD O APARTMENT 402 LAUNDRY |
| 202.4 1 WD PTD 2'-6" 6'-8" 1-3/4" A HM PTD O | APARTMENT 302 BATHROOM, PRIVACY SET 302.4 1 WD PTD | 2'-6" 6'-8" 1-3/4" A HM PTD O O O APARTMENT 402 BATHROOM, PRIVACY |
| 202.5 1 WD PTD 2'-6" 6'-8" 1-3/4" A HM PTD | APARTMENT 302 PRIME BED, PRIVACY SET 302.5 1 WD PTD | 2'-6" 6'-8" 1-3/4" A HM PTD |
| 202.6 1 WD PTD 2'-6" 6'-8" 1-3/4" A HM PTD | APARTMENT 302 W.I.C. 302.6 1 WD PTD | 2'-6" 6'-8" 1-3/4" A HM PTD O APARTMENT 402 W.I.C. |
| 202.7 1 WD PTD 2'-6" 6'-8" 1-3/4" A HM PTD | APARTMENT 302 PRIME BATH, PRIVACY SET 302.7 1 WD PTD | 2'-6" 6'-8" 1-3/4" A HM PTD O O O APARTMENT 402 PRIME BATH, PRIVACY |
| 202.8 1 WD PTD 2'-6" 6'-8" 1-3/4" A HM PTD | APARTMENT 302 BEDROOM, PRIVACY SET 302.8 1 WD PTD | 2'-6" 6'-8" 1-3/4" A HM PTD O O APARTMENT 402 BEDROOM, PRIVACY S |
| 202.9 2 WD PTD 6-0" BF 6'-8" 1-3/4" A HM PTD - - - | APARTMENT 302 CLOSET 302.9 2 WD PTD | 6-0" BF 6'-8" 1-3/4" A HM PTD O APARTMENT 402 CLOSET |
| 202.10 1 WD PTD 2'-6" 6'-8" 1-3/4" A HM PTD | APARTMENT 302 BEDROOM, PRIVACY SET 302.10 1 WD PTD | 2'-6" 6'-8" 1-3/4" A HM PTD APARTMENT 402 BEDROOM, PRIVACY S |
| 202.11 2 WD PTD 6-0" BF 6'-8" 1-3/4" A HM PTD | APARTMENT 302 CLOSET 302.11 2 WD PTD | 6-0" BF 6'-8" 1-3/4" A HM PTD APARTMENT 402 CLOSET |
| 203 3 WD PTD C-LABEL 3'-0" 6'-8" 1-3/4" B HM PTD | APARTMENT 303 ENTRY, ENTRY SET 303 3 WD PTD C-LABEL | |
| 203.1 1 WD PTD 2'-6" 6'-8" 1-3/4" A HM PTD | APARTMENT 303 COAT 303.1 1 WD PTD | 2'-6" 6'-8" 1-3/4" A HM PTD APARTMENT 403 COAT |
| 203.2 1 WD PTD 2'-6" 6'-8" 1-3/4" A HM PTD | APARTMENT 303 PANTRY 303.2 1 WD PTD | 2'-6" 6'-8" 1-3/4" A HM PTD OO APARTMENT 403 PANTRY |
| 203.3 2 WD PTD 5'-0" BF 6'-8" 1-3/4" A HM PTD | APARTMENT 303 LAUNDRY 303.3 2 WD PTD | 5'-0" BF 6'-8" 1-3/4" A HM PTD APARTMENT 403 LAUNDRY |
| 203.4 1 WD PTD 2'-6" 6'-8" 1-3/4" A HM PTD | APARTMENT 303 BATHROOM, PRIVACY SET 303.4 1 WD PTD | 2'-6" 6'-8" 1-3/4" A HM PTD O O O APARTMENT 403 BATHROOM, PRIVACY |
| 203.5 1 WD PTD 2'-6" 6'-8" 1-3/4" A HM PTD | APARTMENT 303 PRIME BED, PRIVACY SET 303.5 1 WD PTD | 2'-6" 6'-8" 1-3/4" A HM PTD APARTMENT 403 PRIME BED, PRIVACY SI |
| 203.6 1 WD PTD 2'-6" 6'-8" 1-3/4" A HM PTD | APARTMENT 303 W.I.C. 303.6 1 WD PTD | 2'-6" 6'-8" 1-3/4" A HM PTD O APARTMENT 403 W.I.C. |
| 203.7 1 WD PTD 2'-6" 6'-8" 1-3/4" A HM PTD | APARTMENT 303 PRIME BATH, PRIVACY SET 303.7 1 WD PTD | 2'-6" 6'-8" 1-3/4" A HM PTD O O O APARTMENT 403 PRIME BATH, PRIVACY |
| 203.8 1 WD PTD 2'-6" 6'-8" 1-3/4" A HM PTD | APARTMENT 303 BEDROOM, PRIVACY SET 303.8 1 WD PTD | 2'-6" 6'-8" 1-3/4" A HM PTD O O APARTMENT 403 BEDROOM, PRIVACY S |
| 203.9 2 WD PTD 6-0" BF 6'-8" 1-3/4" A HM PTD | APARTMENT 303 CLOSET 303.9 2 WD PTD | 6-0" BF 6'-8" 1-3/4" A HM PTD O APARTMENT 403 CLOSET |
| 203.10 1 WD PTD 2'-6" 6'-8" 1-3/4" A HM PTD | APARTMENT 303 BEDROOM, PRIVACY SET 303.10 1 WD PTD | 2'-6" 6'-8" 1-3/4" A HM PTD O O APARTMENT 403 BEDROOM, PRIVACY S |
| 203.11 2 WD PTD 6-0" BF 6'-8" 1-3/4" A HM PTD | APARTMENT 303 CLOSET 303.11 2 WD PTD | 6-0" BF 6'-8" 1-3/4" A HM PTD APARTMENT 403 CLOSET |
| 204 3 WD PTD C-LABEL 3'-0" 6'-8" 1-3/4" B HM PTD | APARTMENT 304 ENTRY, ENTRY SET 304 3 WD PTD C-LABEL | |
| 204.1 1 WD PTD 2'-6" 6'-8" 1-3/4" A HM PTD | APARTMENT 304 COAT 304.1 1 WD PTD | 2'-6" 6'-8" 1-3/4" A HM PTD APARTMENT 404 COAT |
| 204.2 1 WD PID 2'-6" 6'-8" 1-3/4" A HM PTD | APARTMENT 304 PANTRY 304.2 1 WD PTD | 2'-6" 6'-8" 1-3/4" A HM PTD - - - O |
| 204.3 2 WD PTD 5'-0" BF 6'-8" 1-3/4" A HM PTD | APARTMENT 304 LAUNDRY 304.3 2 WD PTD | 5'-0" BF 6'-8" 1-3/4" A HM PTD APARTMENT 404 LAUNDRY |
| 204.4 1 WD PTD 2'-6" 6'-8" 1-3/4" A HM PTD O | APARTMENT 304 BATHROOM, PRIVACY SET 304.4 1 WD PTD | 2'-6" 6'-8" 1-3/4" A HM PTD O O O APARTMENT 404 BATHROOM, PRIVACY |
| 204.5 1 WD PTD 2'-6" 6'-8" 1-3/4" A HM PTD | APARTMENT 304 PRIME BED, PRIVACY SET 304.5 1 WD PTD | 2'-6" 6'-8" 1-3/4" A HM PTD APARTMENT 404 PRIME BED, PRIVACY SI |
| 204.6 1 WD PTD 2'-6" 6'-8" 1-3/4" A HM PTD | APARTMENT 304 W.I.C. 304.6 1 WD PTD | 2'-6" 6'-8" 1-3/4" A HM PTD O APARTMENT 404 W.I.C. |
| 204.7 1 WD PTD 2'-6" 6'-8" 1-3/4" A HM PTD | APARTMENT 304 PRIME BATH, PRIVACY SET 304.7 1 WD PTD | 2'-6" 6'-8" 1-3/4" A HM PTD APARTMENT 404 PRIME BATH, PRIVACY |
| 204.8 1 WD PTD 2'-6" 6'-8" 1-3/4" A HM PTD | APARTMENT 304 BEDROOM, PRIVACY SET 304.8 1 WD PTD | 2'-6" 6'-8" 1-3/4" A HM PTD O O APARTMENT 404 BEDROOM, PRIVACY S |
| 204.9 2 WD PTD 6-0" BF 6'-8" 1-3/4" A HM PTD | APARTMENT 304 CLOSET 304.9 2 WD PTD | 6-0" BF 6'-8" 1-3/4" A HM PTD O APARTMENT 404 CLOSET |
| 204.10 1 WD PTD 2'-6" 6'-8" 1-3/4" A HM PTD O | APARTMENT 304 BEDROOM, PRIVACY SET 304.10 1 WD PTD | 2'-6" 6'-8" 1-3/4" A HM PTD O O APARTMENT 404 BEDROOM, PRIVACY S |
| 204.11 2 WD PTD 6-0" BF 6'-8" 1-3/4" A HM PTD | APARTMENT 304 CLOSET 304.11 2 WD PTD | 6-0" BF 6'-8" 1-3/4" A HM PTD O APARTMENT 404 CLOSET |
| 205 5 HM PTD B-LABEL 3'-0" 6'-8" 1-3/4" B HM PTD | | BEL 3'-0" 6'-8" 1-3/4" B HM PTD OO OO OO STAIR B INTERIOR |
| 206 5 HM PTD B-LABEL 3'-0" 6'-8" 1-3/4" B HM PTD - - - | STAIR A INTERIOR 306 5 HM PTD B-LABEL | BEL 3'-0" 6'-8" 1-3/4" B HM PTD - - - |

| ACHITECT: SOO MAIN STREET WORCESTER, MASSACHUSETTS 01608 (T) 508.755.0533 (C) 508.372.5368 ADMIN@DIXONSALOARCHITECTS.COM |
|--|
| ARCHITECT'S STAMP: |
| ENGINEER: |
| ENGINEER'S STAMP: |
| GENERAL INFORMATION: |

| SCHEMATIC 12.20.2022 DESIGN DEVELOPMENT 12.08.2023 BID PERMIT CONSTRUCTION EXISTING CONDITIONS |
|--|

| | □ PERMIT□ CONSTRUCTION□ EXISTING CONDITION | S |
|----|--|------------|
| 4 | | |
| 3 | | |
| 2 | | |
| 1 | | |
| | revision dati | E |
| | | |
| DA | ΓE: | 02.05.2024 |
| SC | ALE: | AS NOTED |

| SCALE: | AS NOTED |
|---|----------|
| PROJECT: | |
| DRAWN: | JGH |
| CHECKED: | JGH |
| PROJECT TITLE: RESIDENTIAL BUILDING 11 PARKER | |

11 PARKER WORCESTER, MA 01610

SHEET TITLE: DOOR SCHEDULE

SHEET NUMBER:

Δ_8 1

NEW CONSTRUCTION:

PROPOSED MULTI-FAMILY

PROJECT LOCATION
53 MASON STREET
WORCESTER, MA

DEVELOPER
POLAR VIEWS
89 WEST MAIN STREET, UNIT 101
NORTHBOROUGH, MA 01532
MR DANIEL YARNIE

STRUCTURAL ENGINEER
ROOME & GUARRACINO, LLC
48 GROVE STREET
SOMERVILLE, MA 02144
MR. CARMINE GUARRACINO, PE
(T) 617.628.1700

GUARRACINO@RGENG.COM

ARCHITECT

DIXON SALO ARCHITECTS, INC.

300 MAIN STREET, FIRST FLOOR

WORCESTER, MA 01608

MR. JESSE HILGENBERG

IHILGENBERG@DIXONSALOARCHITEC

JHILGENBERG@DIXONSALOARCHITECTS.COM

(T) 508.755.0533


MECHANICAL ENGINEER
AKAL ENGINEERING, INC.
44 CENTRAL STREET
BERLIN, MA 01503
(T) 508.869.0403
MR. ANUP KHATRA

ANUP@AKALENGINEERING.COM


ABBREVIATIONS ABOVE FINISHED FLOOR MASONRY OPENING AVERAGE BEAM BOARD BRASS BRONZE BUILDING BUILT-IN CABINET CEILING CENTER LINE CENTIMETER **MECHANICAL** CERAMIC CLEAR COLD WATER COLUMN CONCRETE OPPOSITE PAINTED PARTITION CONCRETE MASONRY UNIT CONSTRUCTION CONTINUOUS CONTRACTOR PLUMBING PLYWOOD PRESSURE TREATED DEMOLITION DIMENSION DOOR DOWN DRAWING DRINKING FOUNTAIN EACH ELECTRIC ELECTRIC WATER COOLER ROUGH OPENING SCHEDULE SECTION SHEET SIMILAR SOLID CORE EXISTING EXTERIOR FABRICATE FEET FINISH FINISHED ALL OVER FIREPROOF FLOOR SQUARE INCHES STAINLESS STEEL FLUORESCEN SUSPENDED GENERAL GLASS GYPSUM BOARD TEMPERATURE TONGUE & GROOVE HARDWARE HARDWOOD HOLLOW CORE HORIZONTAL HOT WATER **VENT THROUGH ROOF**

INSULATION
INTERIOR
JUNCTION BOX
LAVATORY
LIGHT


VERIFY IN THE FIELD

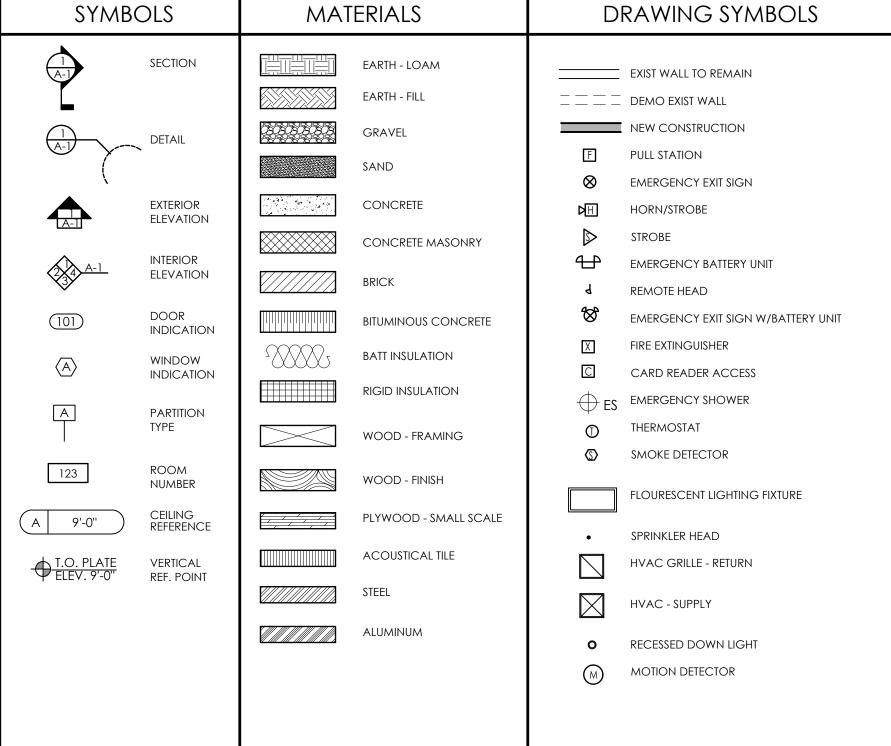

LEGEND

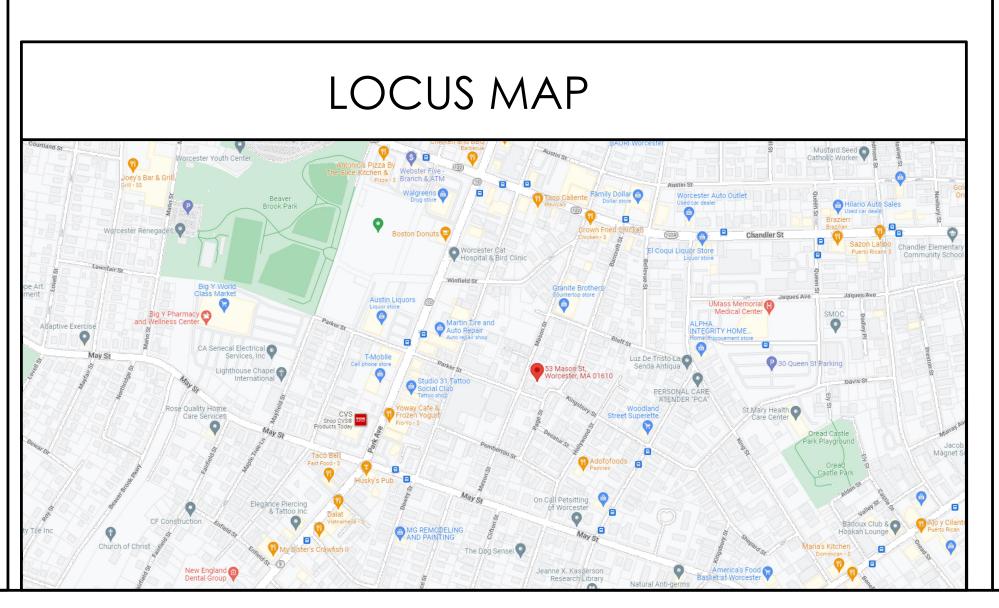

LIST OF DRAWINGS

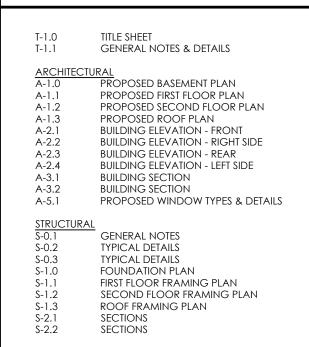



ARCHITECT'S STAMP:

ENGINEER:

ENGINEER'S STAMP:

GENERAL INFORMATION:

SCHEMATIC 12.16.2022
DESIGN DEVELOPMENT 12.19.2022
BID N/A
PERMIT 03.21.2023
CONSTRUCTION
EXISTING CONDITIONS

3
2 WINDOW ON END WALLS - 10.23.2023
1 GARAGE DOOR LOCATION - 08.18.2023
REVISION DATE

DATE: 10.23.2023

SCALE: AS NOTED

PROJECT: -
DRAWN: JGH

CHECKED: JGH

PROJECT TITLE:

PROPOSED MULTI-FAMILY 53 MASON STREET WORCESTER, MA 01610

SHEET TITLE: TITLE SHEET

SHEET NUMBER:

T-1.0

GENERAL DEMOLITION NOTES

A. CONTRACTOR SHALL VISUALLY INSPECT THE SITE TO DETERMINE THE CONDITION OF EXISTING CONSTRUCTION AND FAMILIARIZE HIMSELF/HERSELF WITH THE PROPOSED WORK.

- 1. ALL WORK SHALL COMPLY WITH MUNICIPAL, STATE AND FEDERAL RULES AND REGULATIONS, LAWS AND ORDINANCES OF ALL THE AUTHORITIES HAVING JURISDICTION.
- 2. DISCONNECTION OF UTILITIES REQUIRED BY THE WORK SHALL BE PERFORMED BY QUALIFIED PERSONNEL.
- 3. ALL WORK IS TO COMPLY WITH APPLICABLE PROVISIONS OF ANSI CODE FOR BUILDING CONSTRUCTION; ANSI 10.6, SAFETY OF DEMOLITION.
- 4. UTILITY LINES TO BE ABANDONED SHALL BE DISCONNECTED. REMOVE AS REQUIRED, AND/OR CAPPED
- OFF IN ACCORDANCE WITH APPLICABLE CODE AND REGULATIONS.

 5. REMOVE ALL AREAS SHOWN DASHED (TYPICAL) ON DEMOLITION PLANS.
- 6. CONTRACTOR TO PROTECT ALL EXISTING AREAS BEYOND LIMIT OF WORK OR ITEMS THAT ARE TO REMAIN, AS REQUIRED.
- 7. COORDINATE DEMOLITION WORK WITH PROPOSED NEW WORK SHOWN ON PROJECT DRAWINGS.
- 8. THE GENERAL CONTRACTOR SHALL NOT INTERFERE WITH NORMAL ACTIVITY IN OR ADJACENT TO THE BUILDING, AND IS SHALL TAKE ALL NECESSARY SAFETY PRECAUTIONS TO PREVENT EXCESSIVE DUST, AND NOISE. ACCESS AND EGRESS TO AND FROM THE EXISTING BUILDING AS WELL AS FIRE PROTECTION IS TO BE MAINTAINED AT ALL TIMES THROUGHOUT THE ENTIRE CONSTRUCTION PROCESS.
- 9. PROVIDE ALL TEMPORARY SHORING BRACING, FRAMING, AND PROTECTION OF EXISTING WORK TO REMAIN BEFORE PROCEEDING WITH DEMOLITION AND DURING ALTERATION WORK.
- 10. PERFORM DEMOLITION WORK AS REQUIRED TO ACCOMMODATE NEW CONSTRUCTION.

 CONTRACTOR SHALL VERIFY THAT ALL REMOVED COMPONENTS ARE NOT STRUCTURAL, NOTIFY ARCHITECT BEFORE REMOVING ANY STRUCTURAL MEMBERS. NOTIFY ARCHITECT IN CASE OF DISCREPANCY BEFORE PROCEEDING WITH WORK.
- 11. IF DURING DEMOLITION CONDITIONS ARE REVEALED THAT MAY JEOPARDIZE THE INTEGRITY OF THE STRUCTURE OR PRECLUDE THE DESIGN INTENT, THE GENERAL CONTRACTOR SHALL NOTIFY THE ARCHITECT IMMEDIATELY.
- 12. DEMOLITION PLANS ASSUME THAT PORTIONS OF EXISTING WIRING, PLUMBING, EQUIPMENT, DUCTWORK, ETC., IN AREAS OF NEW WORK WILL BE REQUIRED TO BE REMOVED/RELOCATED TO MEET THE REQUIRED DESIGN PARAMETERS OF THE NEW WORK. PRIOR TO COMMENCING DEMOLITION/RELOCATION, CONTRACTOR SHALL VERIFY SPECIFIC CONDITIONS IN THE FIELD AND COORDINATE WITH GC AND ARCHITECT. (SEE M.E.P. DEMOLITION NOTES.)
- 13. BEFORE DISPOSING OF ANY REMOVED ITEMS, CONSULT WITH OWNER AND VERIFY POSSIBLE RE-USE, SALVAGE, OR DISPOSAL OF ANY EXISTING ITEMS AND EQUIPMENT, INCLUDING BUT NOT LIMITED TO, PLUMBING, FIXTURES, EQUIPMENT, LIGHT FIXTURES AND DOORS, ETC.

B. CUTTING AND PATCHING

- 14. GENERAL CONTRACTOR IS RESPONSIBLE FOR COORDINATION OF ALL SUBCONTRACTORS, DEMOLITION CUTTING AND PATCHING
- 15. ALL PARTITIONS, FLOORS, CEILINGS OR ITEMS TO BE REMOVED SHALL BE CLEANLY CUT BACK TO THE LIMITS SHOWN ON THE PLANS, SECTIONS, AND DETAILS OR AS DIRECTED BY THE ARCHITECT.
- 16. ALL EXISTING FLOORS, WALLS, AND CEILINGS AFFECTED BY NEW WALL LOCATIONS ARE TO BE PATCHED AND REPAIRED AS NECESSARY TO PROVIDE A SMOOTH UN-NOTICEABLE TRANSITION OF NEW AND EXISTING MATERIALS AND SURFACES.
- 17. PROVIDE CUTTING AND PATCHING AS REQUIRED FOR ALL DEMOLITION AND ALTERATION WORK.
 CUTTING AND PATCHING INCLUDE CUTTING INTO OR THROUGH TO PROVIDE FOR THE INSTALLATION
 OR PERFORMANCE OF OTHER WORK, AND THE SUBSEQUENT FITTING AND PATCHING REQUIRED TO
 RESTORE THE CUT SURFACES TO THEIR ORIGINAL CONDITION.
- REMOVE EXISTING INTERIOR FINISHES AND MATERIALS AS REQUIRED TO ACCOMMODATE NEW WORK.
 ALL ITEMS ARE TO BE REMOVED IN A MANNER SO AS TO NOT DAMAGE THE EXISTING MATERIALS OR FINISHES THAT ARE TO REMAIN OR BE REINSTALLED.
- 20. PERFORM DEMOLITION WORK CAREFULLY. REMOVE MASONRY, STEEL, CONCRETE, WALLS AND OTHER STRUCTURAL ELEMENTS IN SMALL SECTIONS. REMOVE THESE MATERIALS TO A CLEANLY CUT, STRAIGHT LINE, ACCURATELY ESTABLISHED.
- 21. REMOVE FROM THE SITE AND DISPOSE OF LEGALLY, ALL EXISTING MATERIALS, DEMOLITION DEBRIS, TRASH, RUBBISH AND ITEMS THAT WILL NOT BE USED IN THE NEW WORK OR WILL NOT BE REUSED BY THE OWNER. STORAGE OF DEBRIS WILL NOT BE PERMITTED. ALL DEBRIS TO BE REMOVED AND DISPOSED OF IN ACCORDANCE WITH STATE AND LOCAL REGULATIONS.
- 22. COORDINATE REMOVAL OF ANY RATED ASSEMBLIES WITH LOCAL OFFICIALS BEFORE COMMENCING WORK.

C. M.E.P. DEMOLITION NOTES

- 23. SEE ELECTRICAL, HVAC, PLUMBING AND FIRE PROTECTION DRAWINGS FOR LOCATION OF NEW UTILITIES AND DEMOLITION OF EXISTING WORK NOT SHOWN ON THESE PLANS. GC TO COORDINATE ALL WORK WITH SUBCONTRACTORS.
- 24. WHERE EXISTING ELECTRICAL DEVICES OCCUR IN PARTITIONS INDICATED TO BE REMOVED, THE WIRING SHALL BE REMOVED, ALL ELECTRICAL LINES BEING DISCONNECTED SHALL BE ADEQUATELY TRACED AND RECONNECTED AS REQUIRED TO ENSURE PROPER FUNCTION FOR THE ADJACENT AREAS AND TO ENSURE PROPER FUNCTION OF THE EXISTING BUILDING EQUIPMENT OR SYSTEM TO REMAIN. ELECTRICAL CONTRACTOR TO VERIFY ALL ELECTRICAL SYSTEMS PRIOR TO THE COMMENCEMENT OF WORK.
- 25. WHERE EXISTING PLUMBING LINES ARE TO BE REWORKED OR REMOVED, ALL PLUMBING LINES BEING DISCONNECTED SHALL BE ADEQUATELY TRACED AND RECONNECTED AS REQUIRED TO ENSURE PROPER FUNCTION FOR THE ADJACENT AREAS AND TO ENSURE PROPER FUNCTION OF THE EXISTING BUILDING EQUIPMENT TO REMAIN IN PLACE.
- 26. WHERE EXISTING HVAC LINES, DUCTWORK, ETC. ARE TO BE REWORKED, ALL LINES AND EQUIPMENT BEING DISCONNECTED SHOULD BE ADEQUATELY TRACED AND RECONNECTED AS REQUIRED TO ENSURE PROPER FUNCTION FOR THE ADJACENT AREAS AND TO ENSURE PROPER FUNCTION TO THE EXISTING BUILDING EQUIPMENT OR SYSTEMS TO REMAIN.
- 27. COORDINATE WITH MECHANICAL AND ELECTRICAL DRAWINGS FOR LOCATIONS OF ALL NEW PENETRATIONS THRU ROOF, FLOORS, WALLS, AND CEILINGS.

D. CLEANING

28. CONTRACTOR IS FULLY RESPONSIBLE FOR THE CLEANING AND PREPARING OF ALL FLOOR, WALL AND CEILING SURFACES FOR THE INSTALLATION OF NEW MATERIALS AS SCHEDULED, UTILITIES, HVAC AND ELECT. SYSTEMS EQUIPMENT, ETC. AFTER DEMO CLEAN-UP.


OTHER: REMINDERS/SPECIFIC TO INDIVIDUAL PROJECTS

- 29. EXISTING LARGE FLOOR OPENINGS TO BE FILLED ARE INDICATED, SMALLER PIPE HOLES, ETC. TO BE FILLED ARE NOT INDICATED ON THE DRAWINGS. REFER TO DETAILS FOR REQUIREMENTS FOR FILLING SAID OPENINGS.
- 30. ALL EXISTING COLUMNS TO REMAIN UNLESS NOTED.
- 31. ALL EXPOSED UNUSED PIPING AND CONDUITS SHALL BE REMOVED BY THE GENERAL CONTRACTOR. SEE SPECIFICATIONS FOR CAPPING.

GENERAL CONSTRUCTION NOTES

- 1. ALL WORK IS TO BE PERFORMED IN PROFESSIONAL AND WORKMANLIKE MANNER, IN ACCORDANCE WITH ALL APPLICABLE FEDERAL & STATE CODES, INCLUDING THE INTERNATIONAL BUILDING CODE (IBC). THESE INCLUDE, BUT ARE NOT LIMITED TO, THE INTERNATIONAL EXISTING BUILDING CODE (IEBC), MASS STATE BUILDING CODE, THE AMERICAN NATIONAL STANDARD (ANSI), THE INTERNATIONAL ENERGY CONSERVATION CODE (IECC), THE NATIONAL ELECTRIC CODE (NEC), THE INTERNATIONAL PLUMBING CODE (IPC), THE INTERNATIONAL MECHANICAL CODE (IMC), AND THE NATIONAL FIRE PROTECTION STANDARDS, AS WELL AS ALL LOCAL REGULATIONS GOVERING THE PROJECT.
- 2. CONTRACTOR TO VISIT SITE AND TO VERIFY ALL DIMENSIONS AND CONDITIONS IN THE FIELD, AND REPORT ALL DISCREPANCIES TO ARCHITECT, PRIOR TO PROCEEDING WITH WORK.
- 3. ALL MATERIALS USED ON THIS PROJECT SHALL BE IN COMPLIANCE WITH THE APPLICABLE INTERNATIONAL BUILDING CODE.
- 4. THE CONTRACTOR SHALL MAINTAIN COMPLETE AND UP-TO-DATE DRAWINGS AT THE JOB SITE, AND SHALL SUBMIT ACCURATE AS-BUILT DRAWINGS TO ARCHITECT AND OWNER AT END OF PROJECT.
- 5. THE INTENTION OF THE CONTRACT DOCUMENTS IS TO INCLUDE ALL LABOR, MATERIALS, EQUIPMENT AND OTHER ITEMS NECESSARY FOR THE PROPER EXECUTION AND COMPLETION OF THE WORK.
- 6. BY EXECUTING THE CONTRACT, THE CONTRACTOR REPRESENTS THAT THEY HAVE VISITED THE SITE AND HAVE FAMILIARIZED THEM SELF WITH THE CONDITIONS UNDER WHICH THE WORK IS TO BE PERFORMED.
- 7. THE ARCHITECT WILL HAVE AUTHORITY TO REJECT WORK WHICH DOES NOT CONFORM TO THE CONTRACT DOCUMENTS.
- 8. THE CONTRACTOR SHALL SUPERVISE AND DIRECT THE WORK, USING THEIR BEST SKILLS AND ATTENTION. THE CONTRACTOR SHALL BE SOLELY RESPONSIBLE FOR ALL CONSTRUCTION MEANS, METHODS, TECHNIQUES, SEQUENCES, PROCEDURES, & SHORING, AND FOR COORDINATING THE WORK OF ALL SUB-CONTRACTORS.
- 9. EACH CONTRACTOR SHALL PERFORM ALL REQUIRED CUTTING AND PATCHING FOR THEIR OWN TRADE, UNLESS OTHERWISE NOTED.
- 10. DRAWINGS SHALL NOT BE SCALED TO OBTAIN DIMENSIONS.
- 11. CONTRACTOR SHALL PROPERLY PROTECT AND MAKE SAFE WORK PREMISES.
- 12. THE CONTRACTOR SHALL KEEP THE WORKSITE CLEAN AND TIDY, AND AT ALL TIMES SHALL KEEP THE PREMISES FREE FROM ACCUMULATION OF WASTE MATERIALS OR TRASH CAUSED BY THEIR OPERATIONS.
- 13. ALL EXITS SHALL BE KEPT READILY ACCESSIBLE AND UNOBSTRUCTED AT ALL TIMES AND SHALL MAINTAIN REQUIRED EMERGENCY EGRESS DURING CONSTRUCTION.
- 14. THE CONTRACTOR SHALL INDEMNIFY AND HOLD HARMLESS THE OWNER AND THE ARCHITECT, AND THEIR AGENTS AND EMPLOYEES, FROM AND AGAINST ANY CLAIMS, DAMAGES, LOSSES AND EXPENSES INCLUDING ATTORNEY'S FEES ARISING OUT OF OR RESULTING FROM THE PERFORMANCES OF THE WORK.
- 15. THE CONTRACTOR SHALL PAY ALL FEES AND SECURE PERMITS FROM ALL AGENCIES HAVING JURISDICTION AND AT COMPLETION SHALL SEE THAT THE PROJECT IS SIGNED OFF BY THE APPROPRIATE AUTHORITY HAVING JURISDICTION.
- 16. WEATHER PROTECTION: THE CONTRACTOR SHALL AT ALL TIMES PROVIDE PROTECTION AGAINST THE RAIN, WIND, STORM, FROST, OR HEAT SO AS TO MAINTAIN ALL WORK MATERIALS, APPARATUS, AND FIXTURES FROM INJURY OR DAMAGE.
- 17. THE CONTRACTOR SHALL PROTECT ALL AREAS OUTSIDE THE CONTRACT LIMITS AND RESTORE ALL SUCH PROPERTY TO ITS CONDITION PRIOR TO THE START OF THE WORK.
- 18. DAMAGE: ALL WORK DAMAGED BY FAILURE TO PROVIDE PROTECTION SHALL BE REMOVED AND REPLACED WITH NEW WORK AT THE CONTRACTORS EXPENSE. THE CONTRACTOR SHALL UNCONDITIONALLY GUARANTEE ALL MATERIALS AND WORKMANSHIP UNTIL THE DATE OF OWNER'S ACCEPTANCE AND SHALL REPLACE ANY DEFECTIVE WORK WITHIN THAT PERIOD WITHOUT EXPENSES TO THE OWNER AND PAY FOR ALL DAMAGES TO OTHER PARTS OF THE BUILDING CAUSED BY REPAIR OF THEIR WORK.
- 19. ALL FINISHES SHALL COMPLY WITH THE LIMITS FOR FIRE RESISTANCE/FLAMMABILITY AS SPECIFIED IN THE APPLICABLE INTERNATIONAL BUILDING CODE.
- 20. ALL DEMOLITION AND RELOCATING OF EXISTING MEP SYSTEMS EFFECTING NEW PLUMBING, HVAC, AND ELECTRICAL SYSTEMS SHALL BE COORDINATED WITH RESPECTIVE SUBCONTRACTORS.

 RELOCATE/REWORK ALL ACTIVE MECHANICAL AND ELECTRICAL LINES WHERE REQUIRED DUE TO REMOVALS AND NEW LAYOUT. MODIFICATIONS FROM THE DRAWINGS SHALL BE BROUGHT TO THE ATTENTION OF THE ARCHITECT BEFORE COMMENCING WORK.
- 21. CONTRACTORS SHALL COORDINATE WITH PROPERTY MANAGER AS REQUIRED WHEN ITEMS OF NEW PLUMBING WORK REQUIRE ACCESS TO ADJACENT COMMON AREAS, AND TENANT SPACES OUTSIDE AREA OF WORK REPLACE AND RESTORE FINISHES TO MATCH AFTER COMPLETION OF WORK.
- 22. PROVIDE ALL BLOCKING REQUIRED TO INSTALL MILLWORK, EQUIPMENT, CASEWORK, GRAB BARS, RAILINGS, ETC. TYPE AND LOCATION SHALL BE SUBJECT TO REVIEW BY ARCHITECT.
- 23. FOAM IN PLACE INSULATION FOR SMALL GAPS AND VOIDS.
- 24. CAULK ALL JOINTS OF DISSIMILAR MATERIALS.
- 25. PLAN DIMENSIONS ARE TO FACE OF PARTITION AT INTERIOR AND FACE OF FOUNDATION AT EXTERIOR, UNLESS OTHERWISE NOTED.
- 26. REFER TO OWNERS ENVIRONMENTAL REPORT REGARDING CONTAMINANTS AND ASBESTOS ON THE PROJECT SITE/BUILDING.

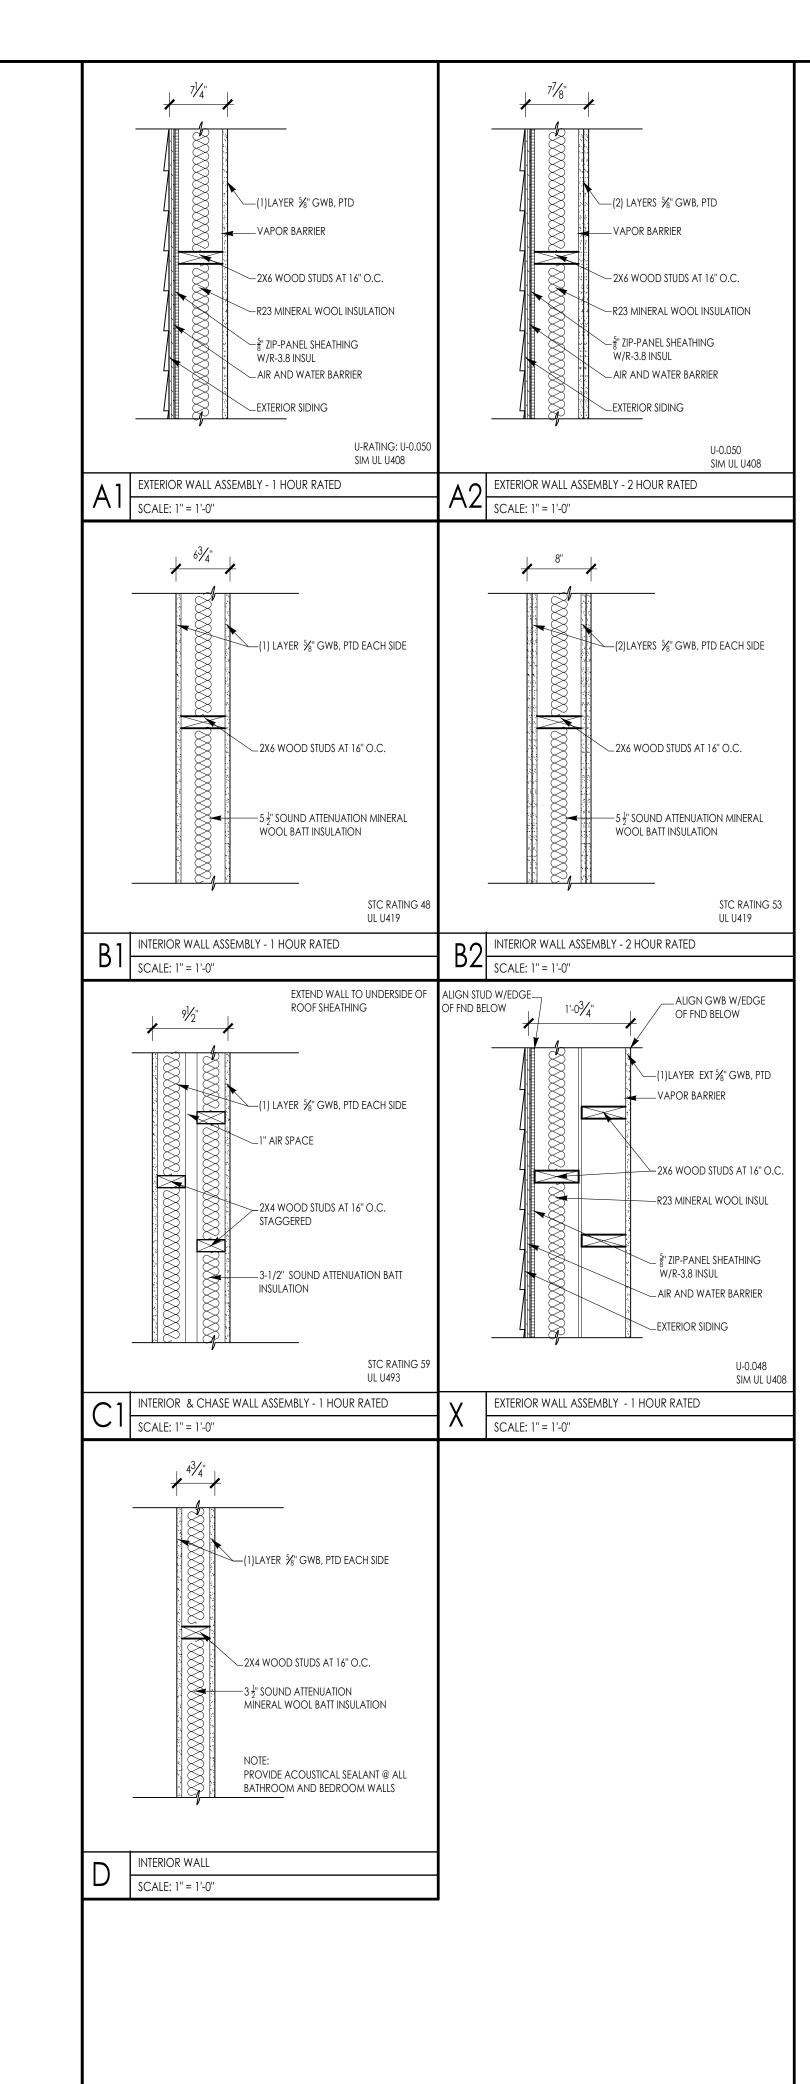



ENGINEER:

ENGINEER'S STAMP:

GENERAL INFORMATION:

SCHEMATIC 12.16.2022
DESIGN DEVELOPMENT 12.19.2022
BID N/A
PERMIT 03.21.2023
CONSTRUCTION
EXISTING CONDITIONS

4
3

DATE: 10.23.2023

SCALE: AS NOTED

PROJECT: -
DRAWN: JGH

JGH

WINDOW ON END WALLS - 10.23.2023

GARAGE DOOR LOCATION - 08.18.2023


REVISION DATE

CHECKED:
PROJECT TITLE:
PROPOSED MULTI-FAMILY
53 MASON STREET
WORCESTER, MA 01610


SHEET TITLE:
GENERAL NOTES & DETAILS

SHEET NUMBER:

T-1.1

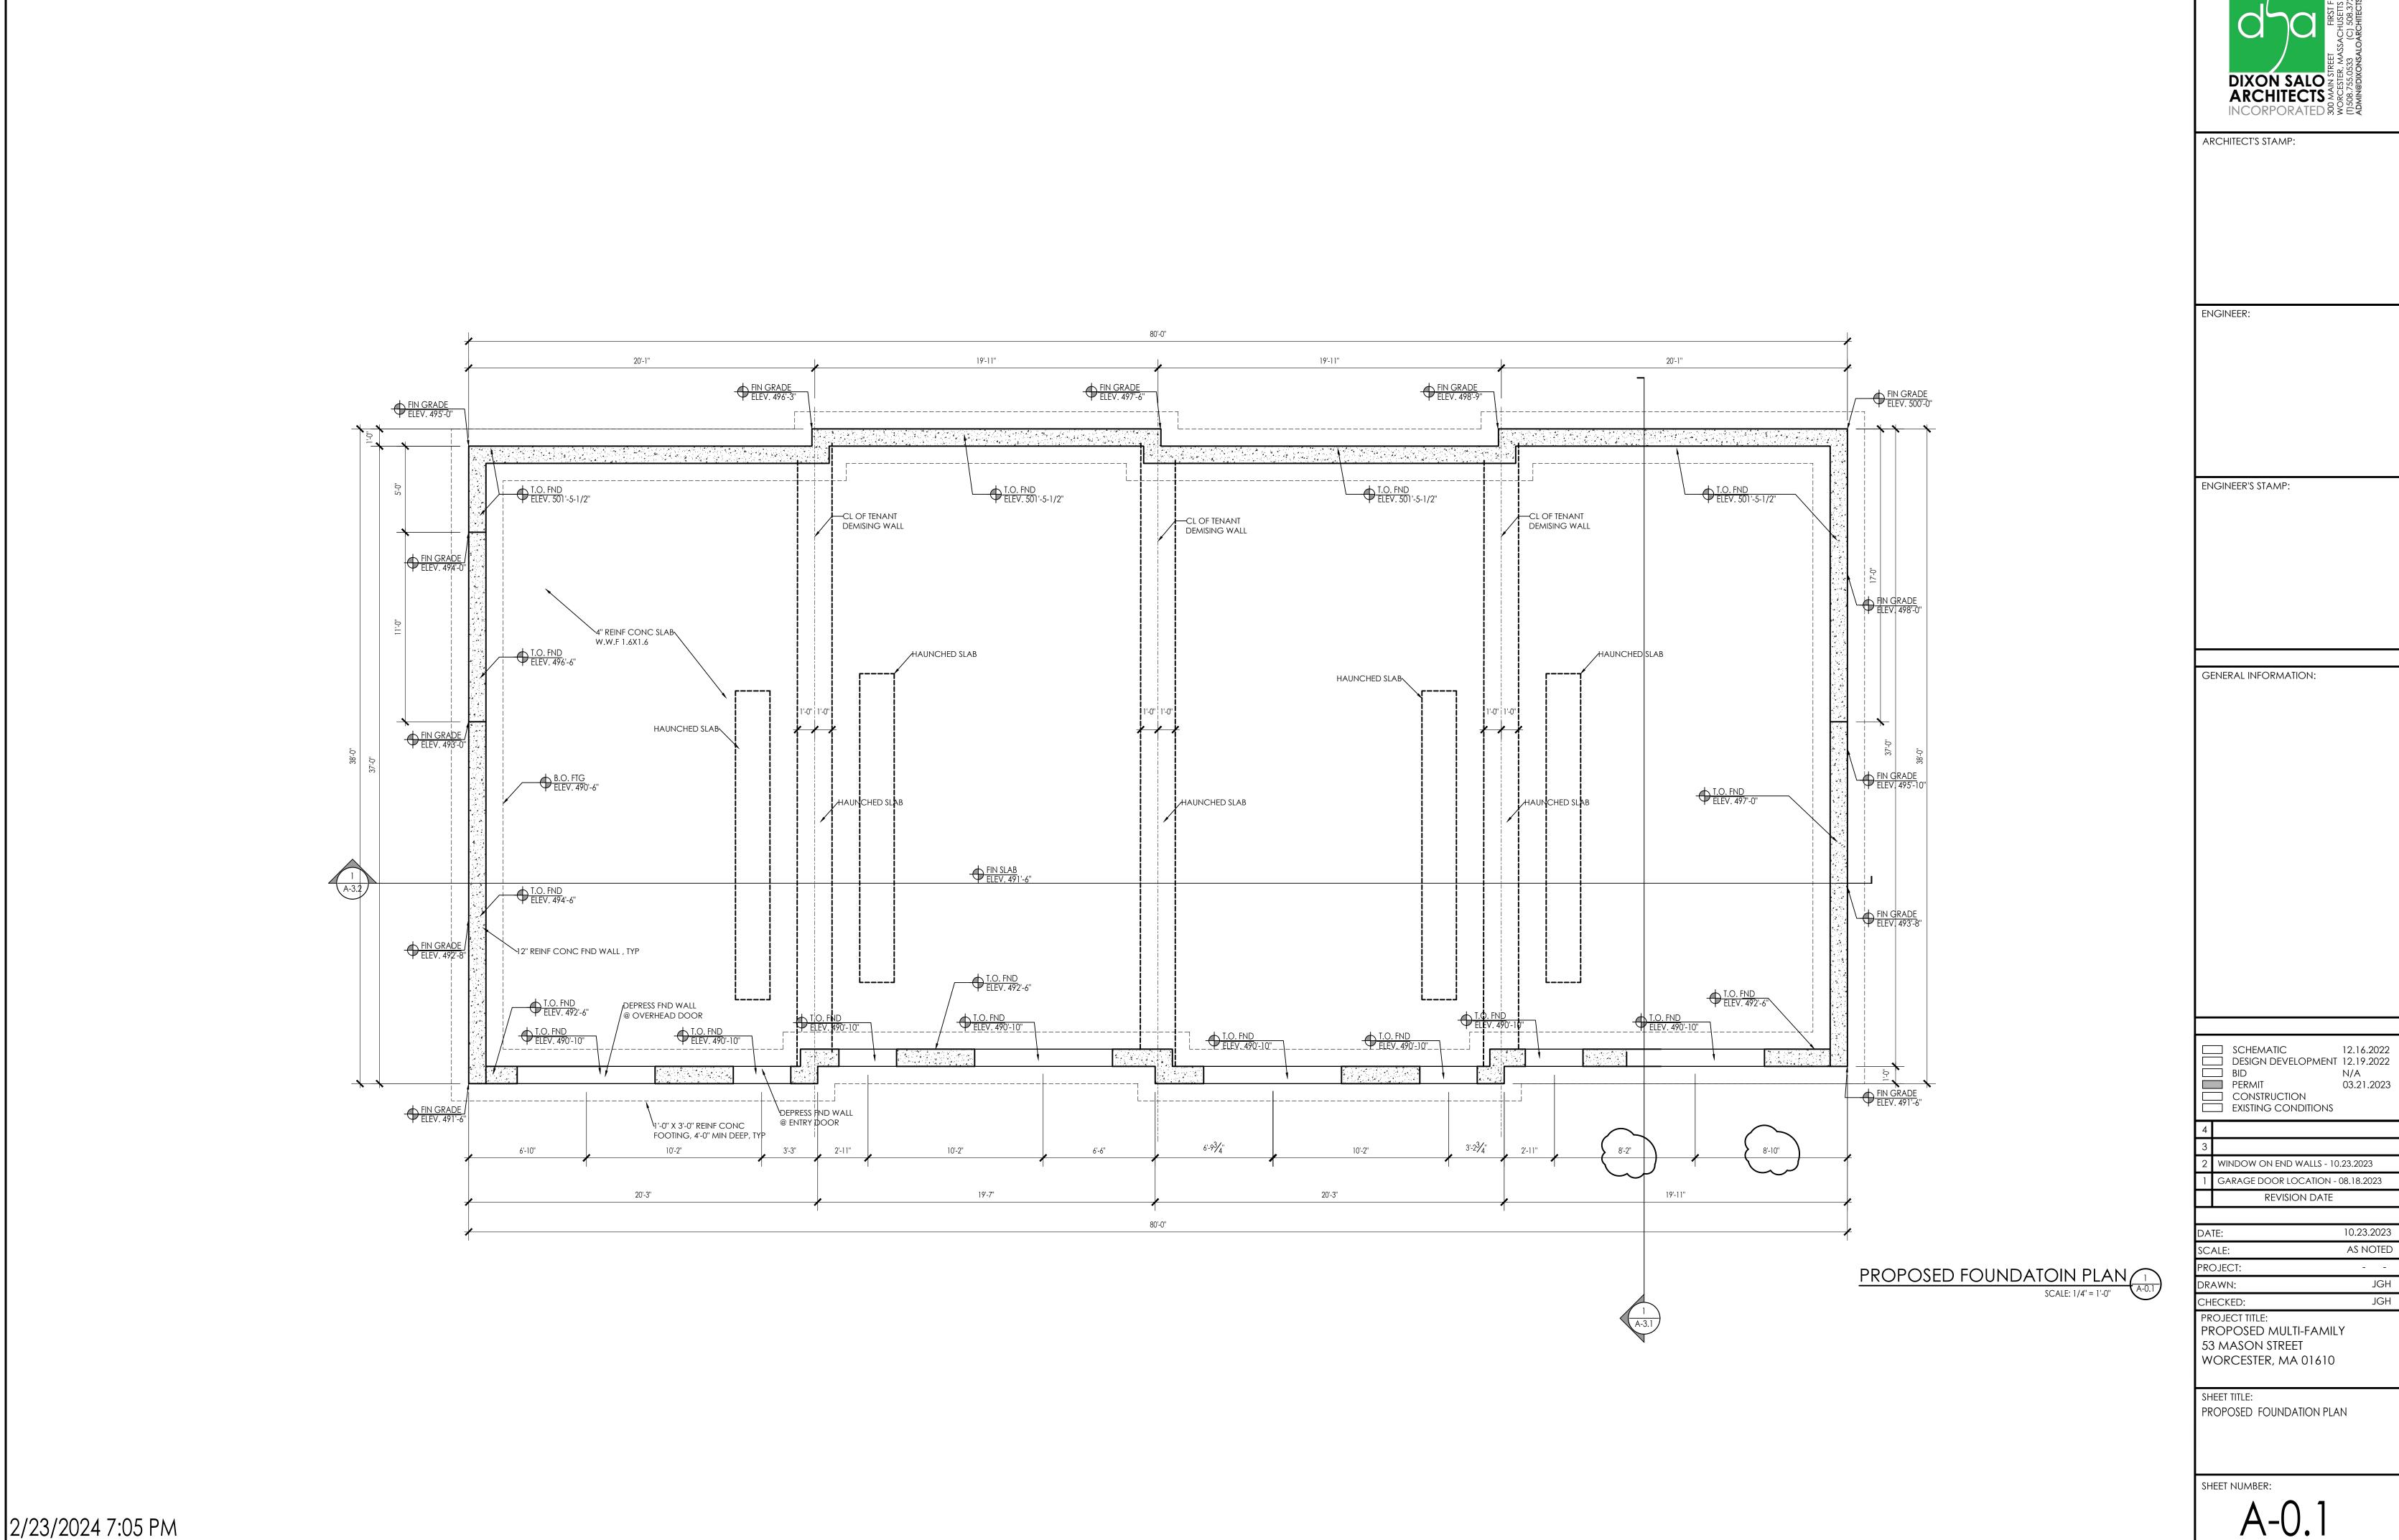



10.23.2023 AS NOTED

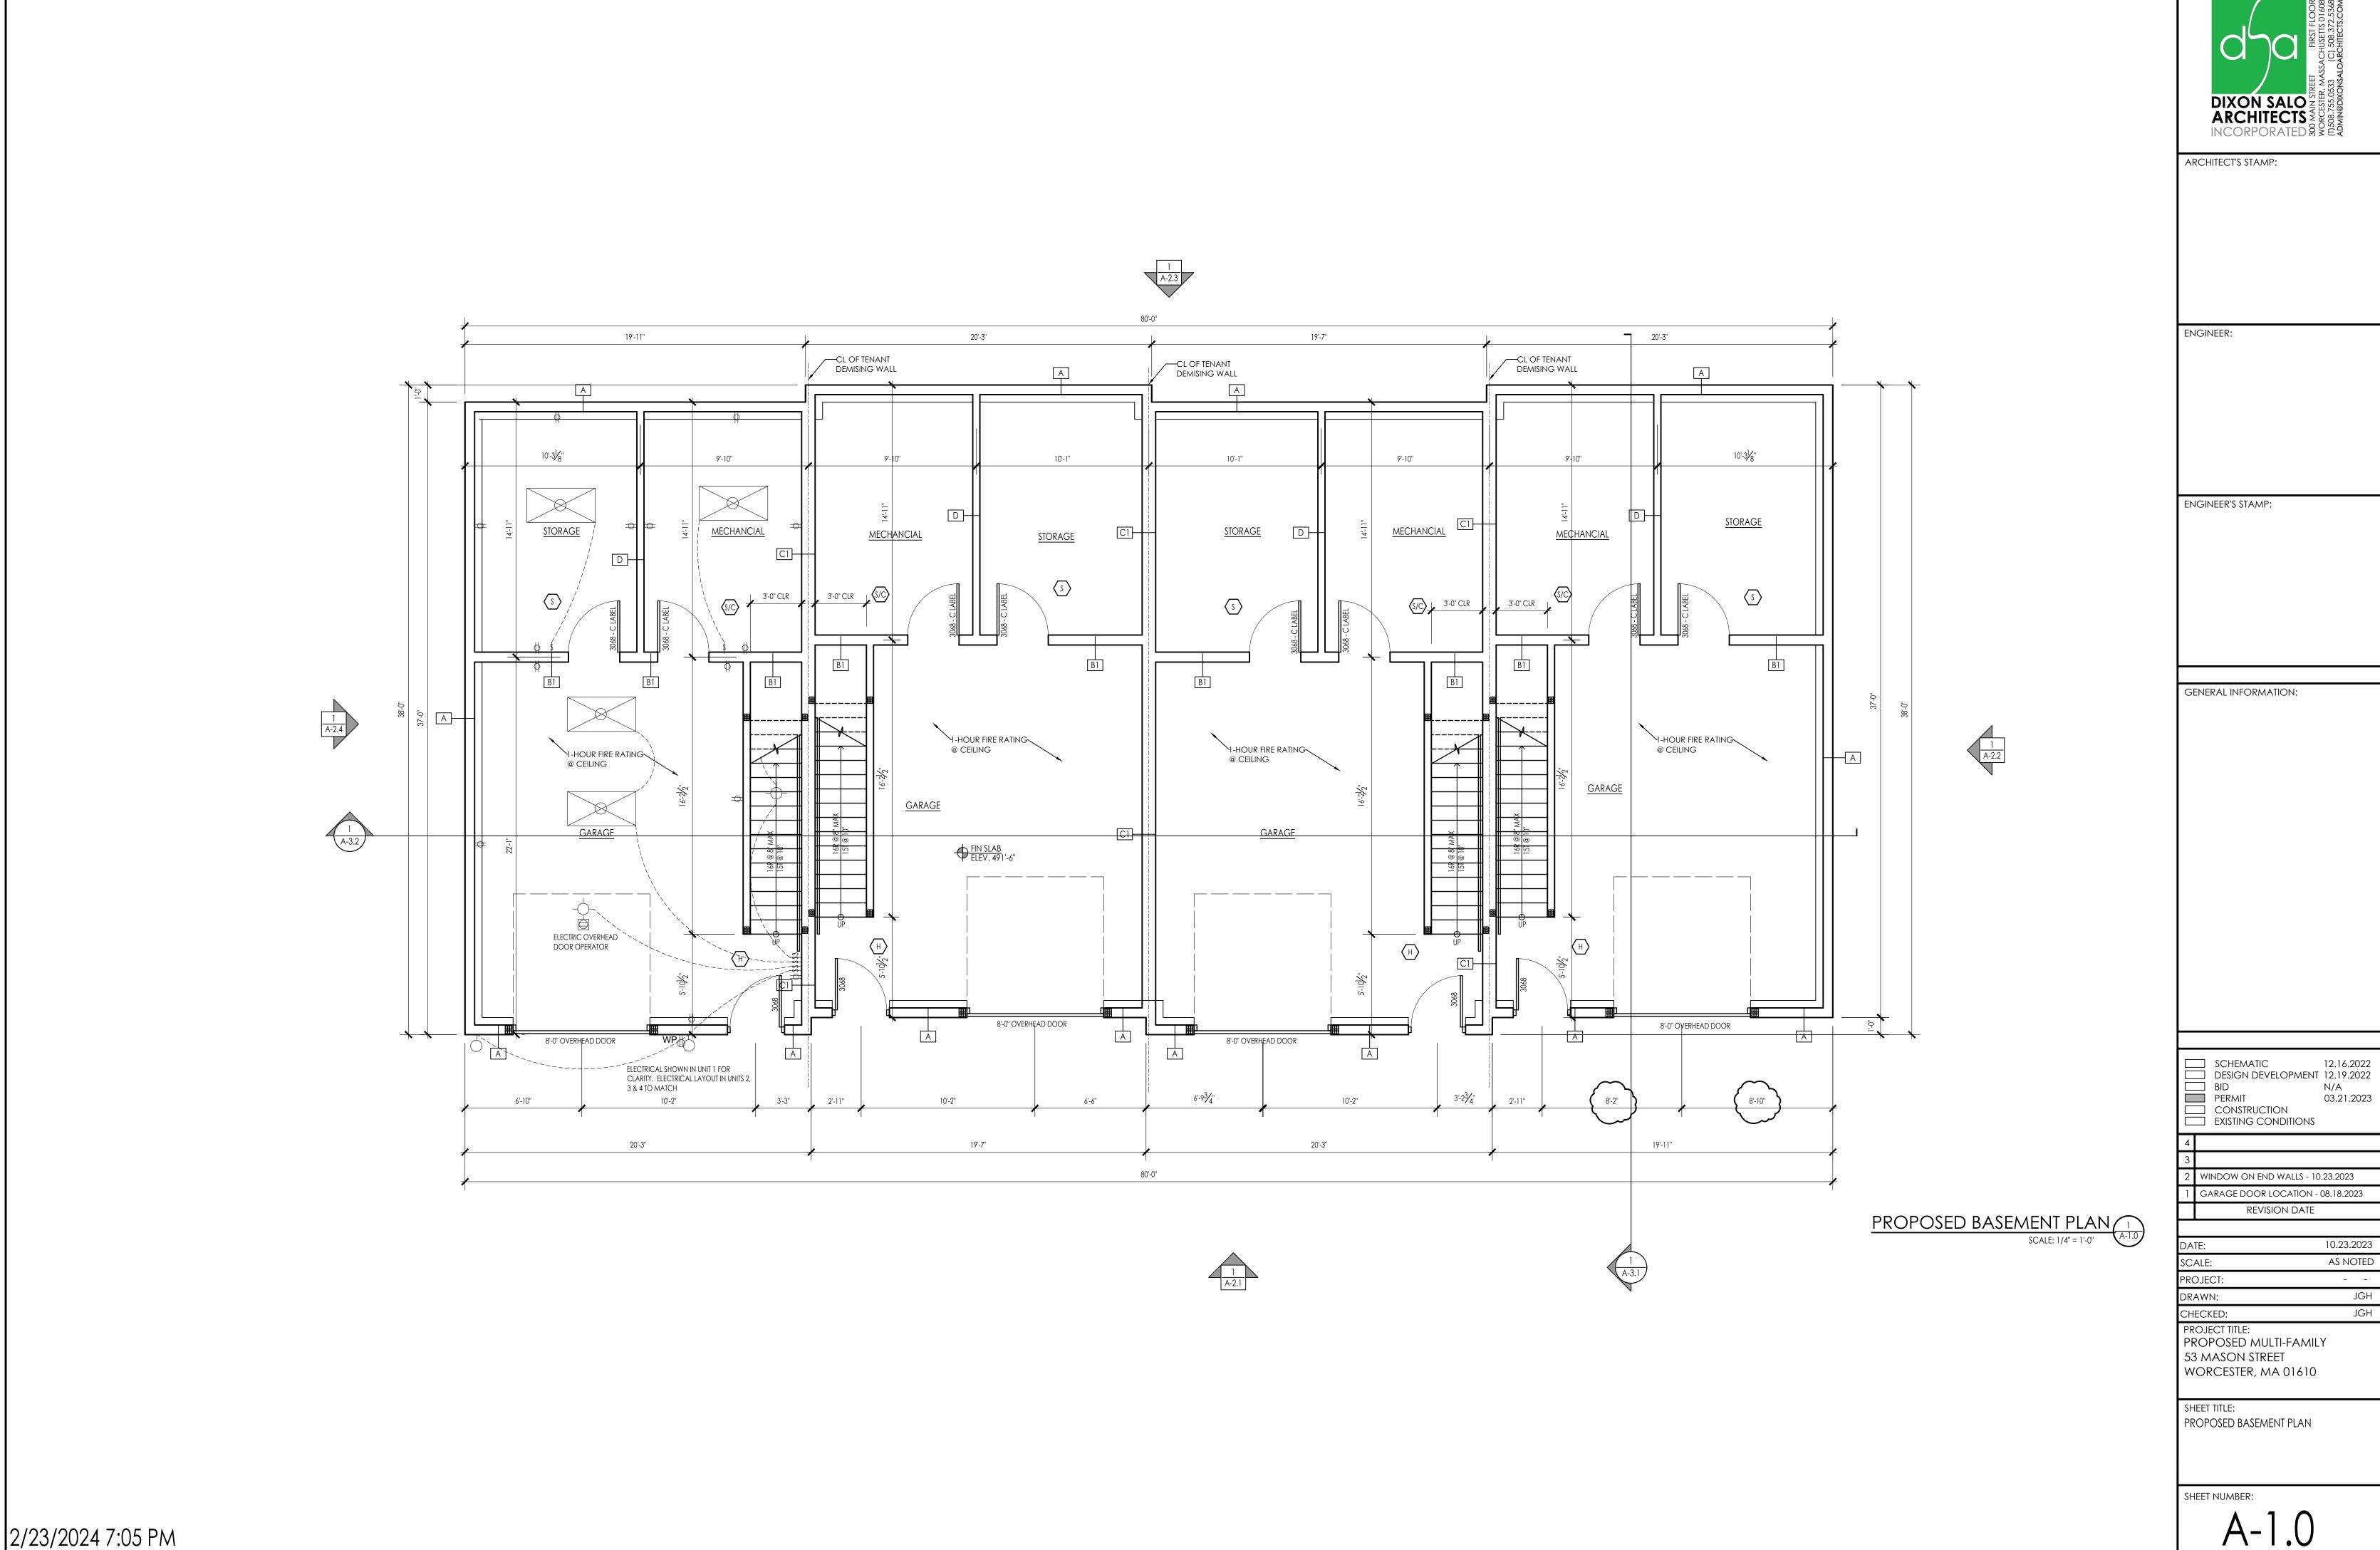

03.21.2023

10.23.2023 AS NOTED

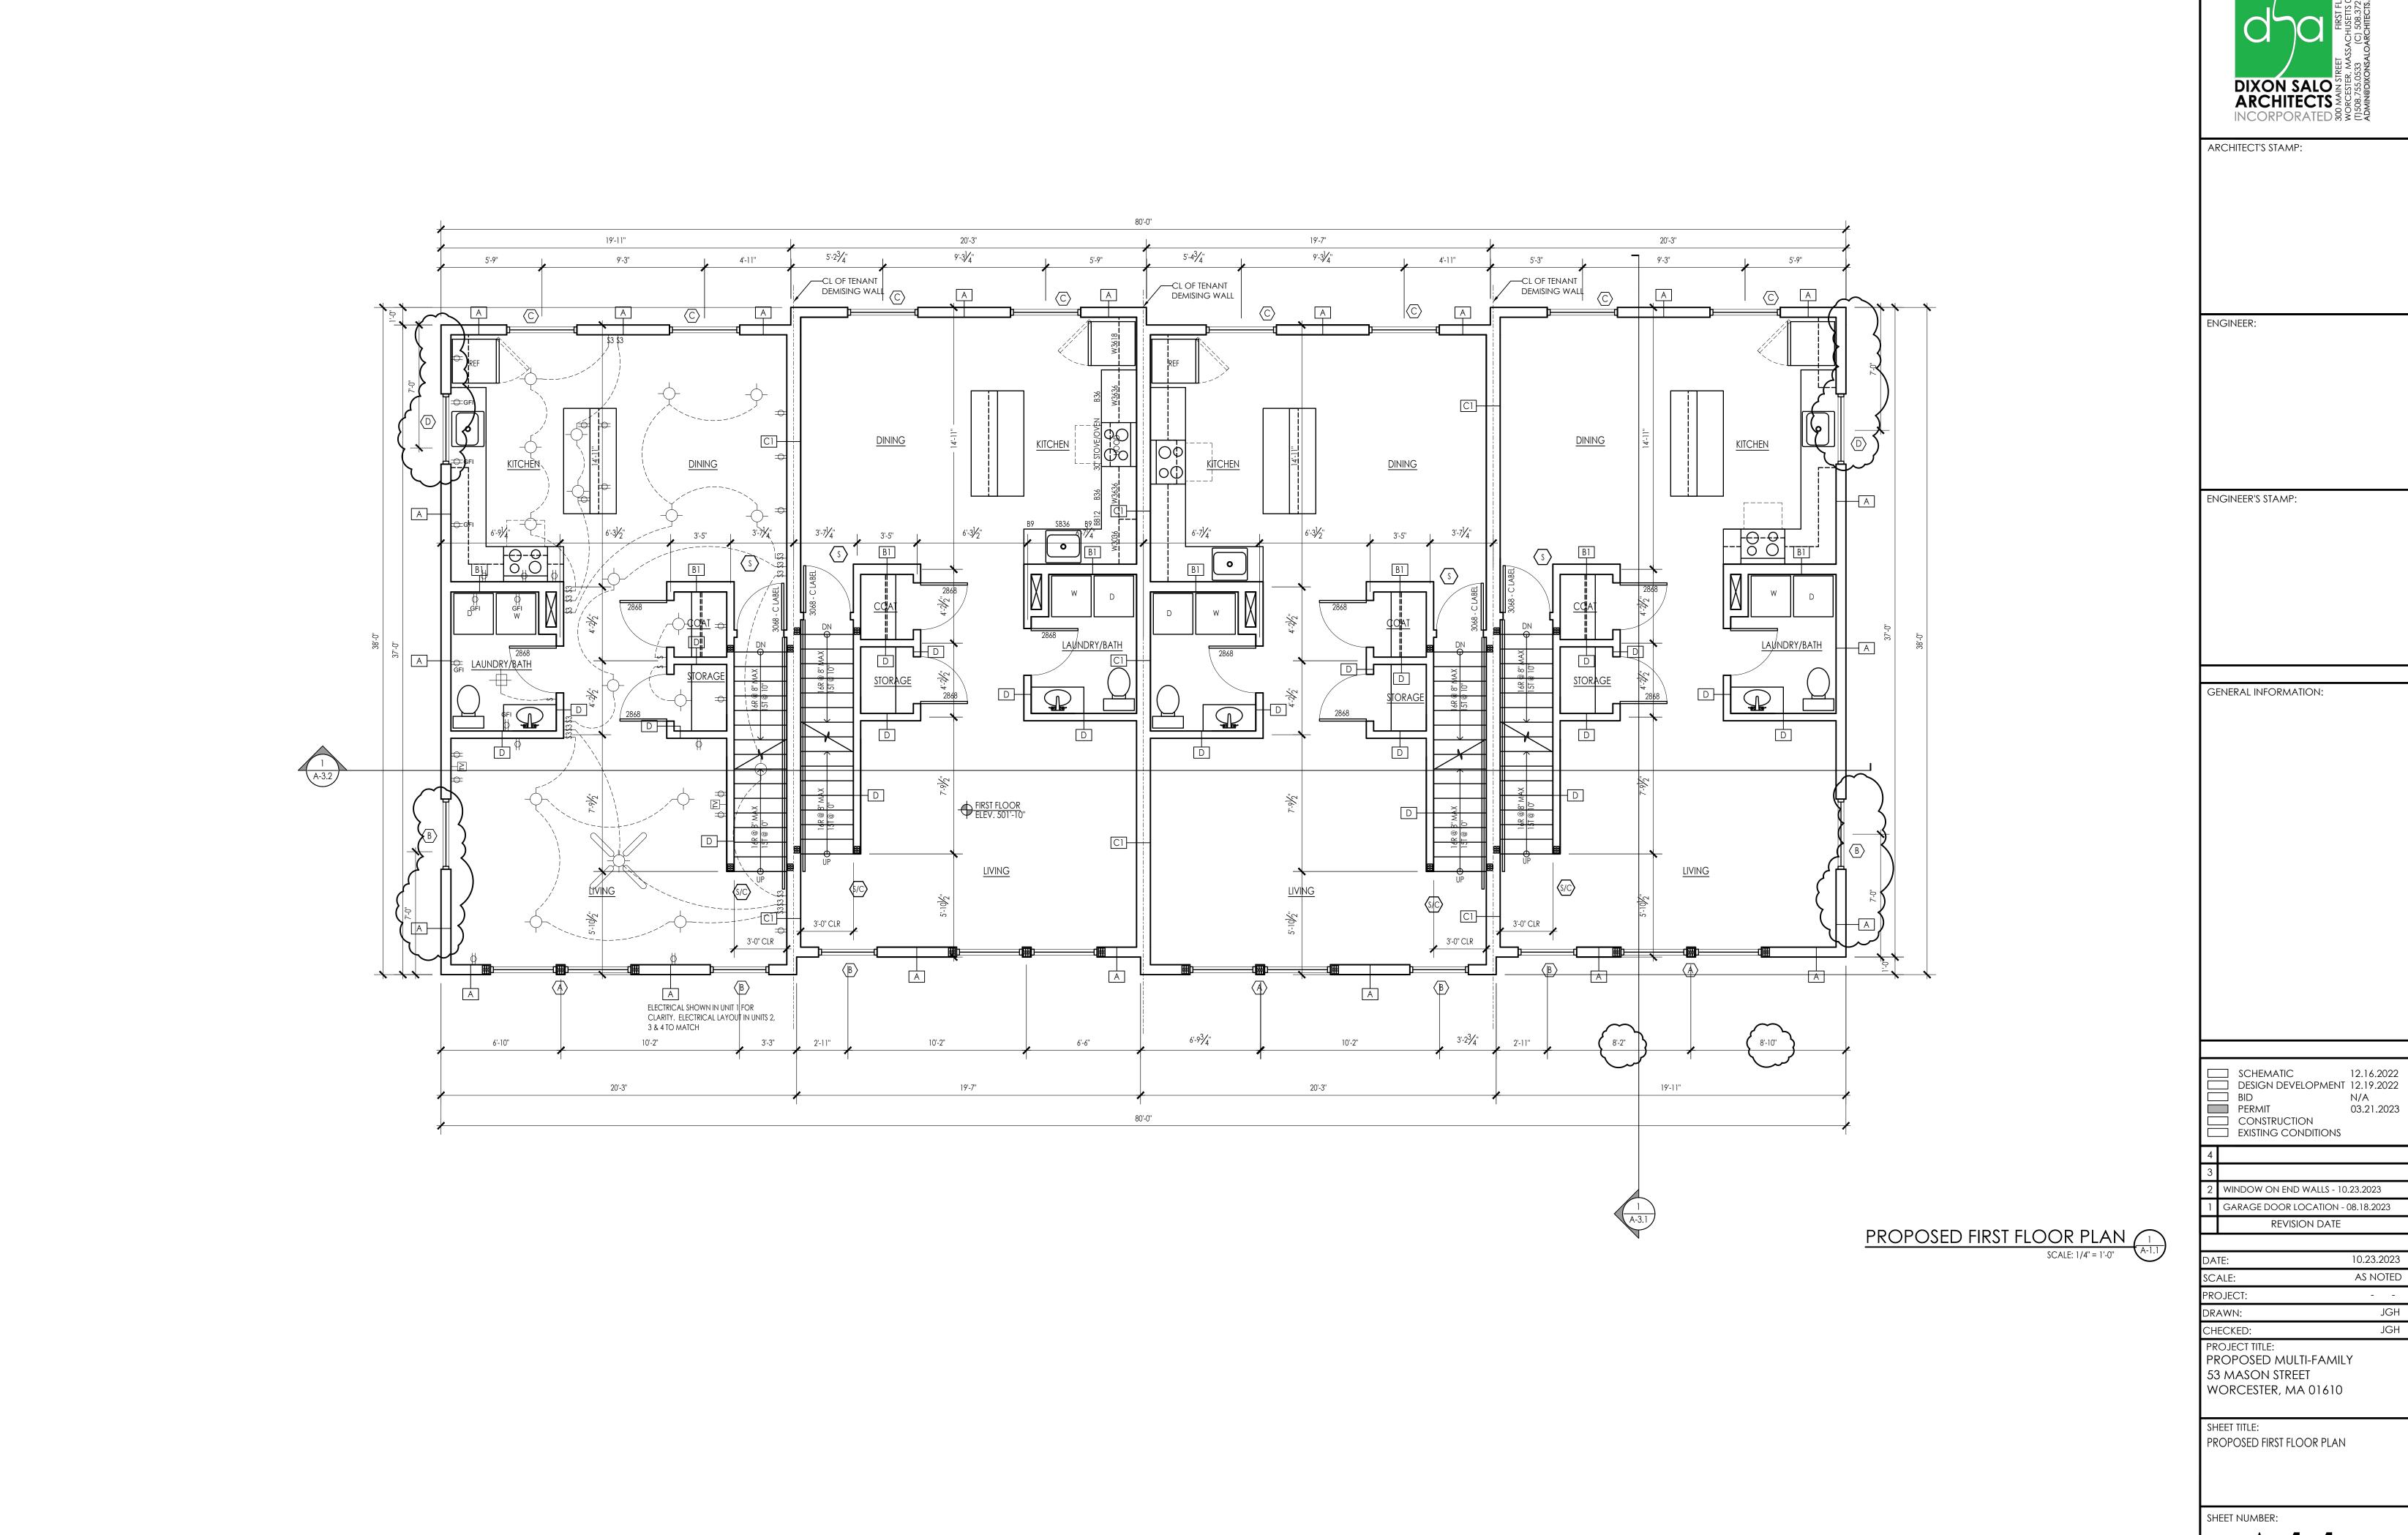

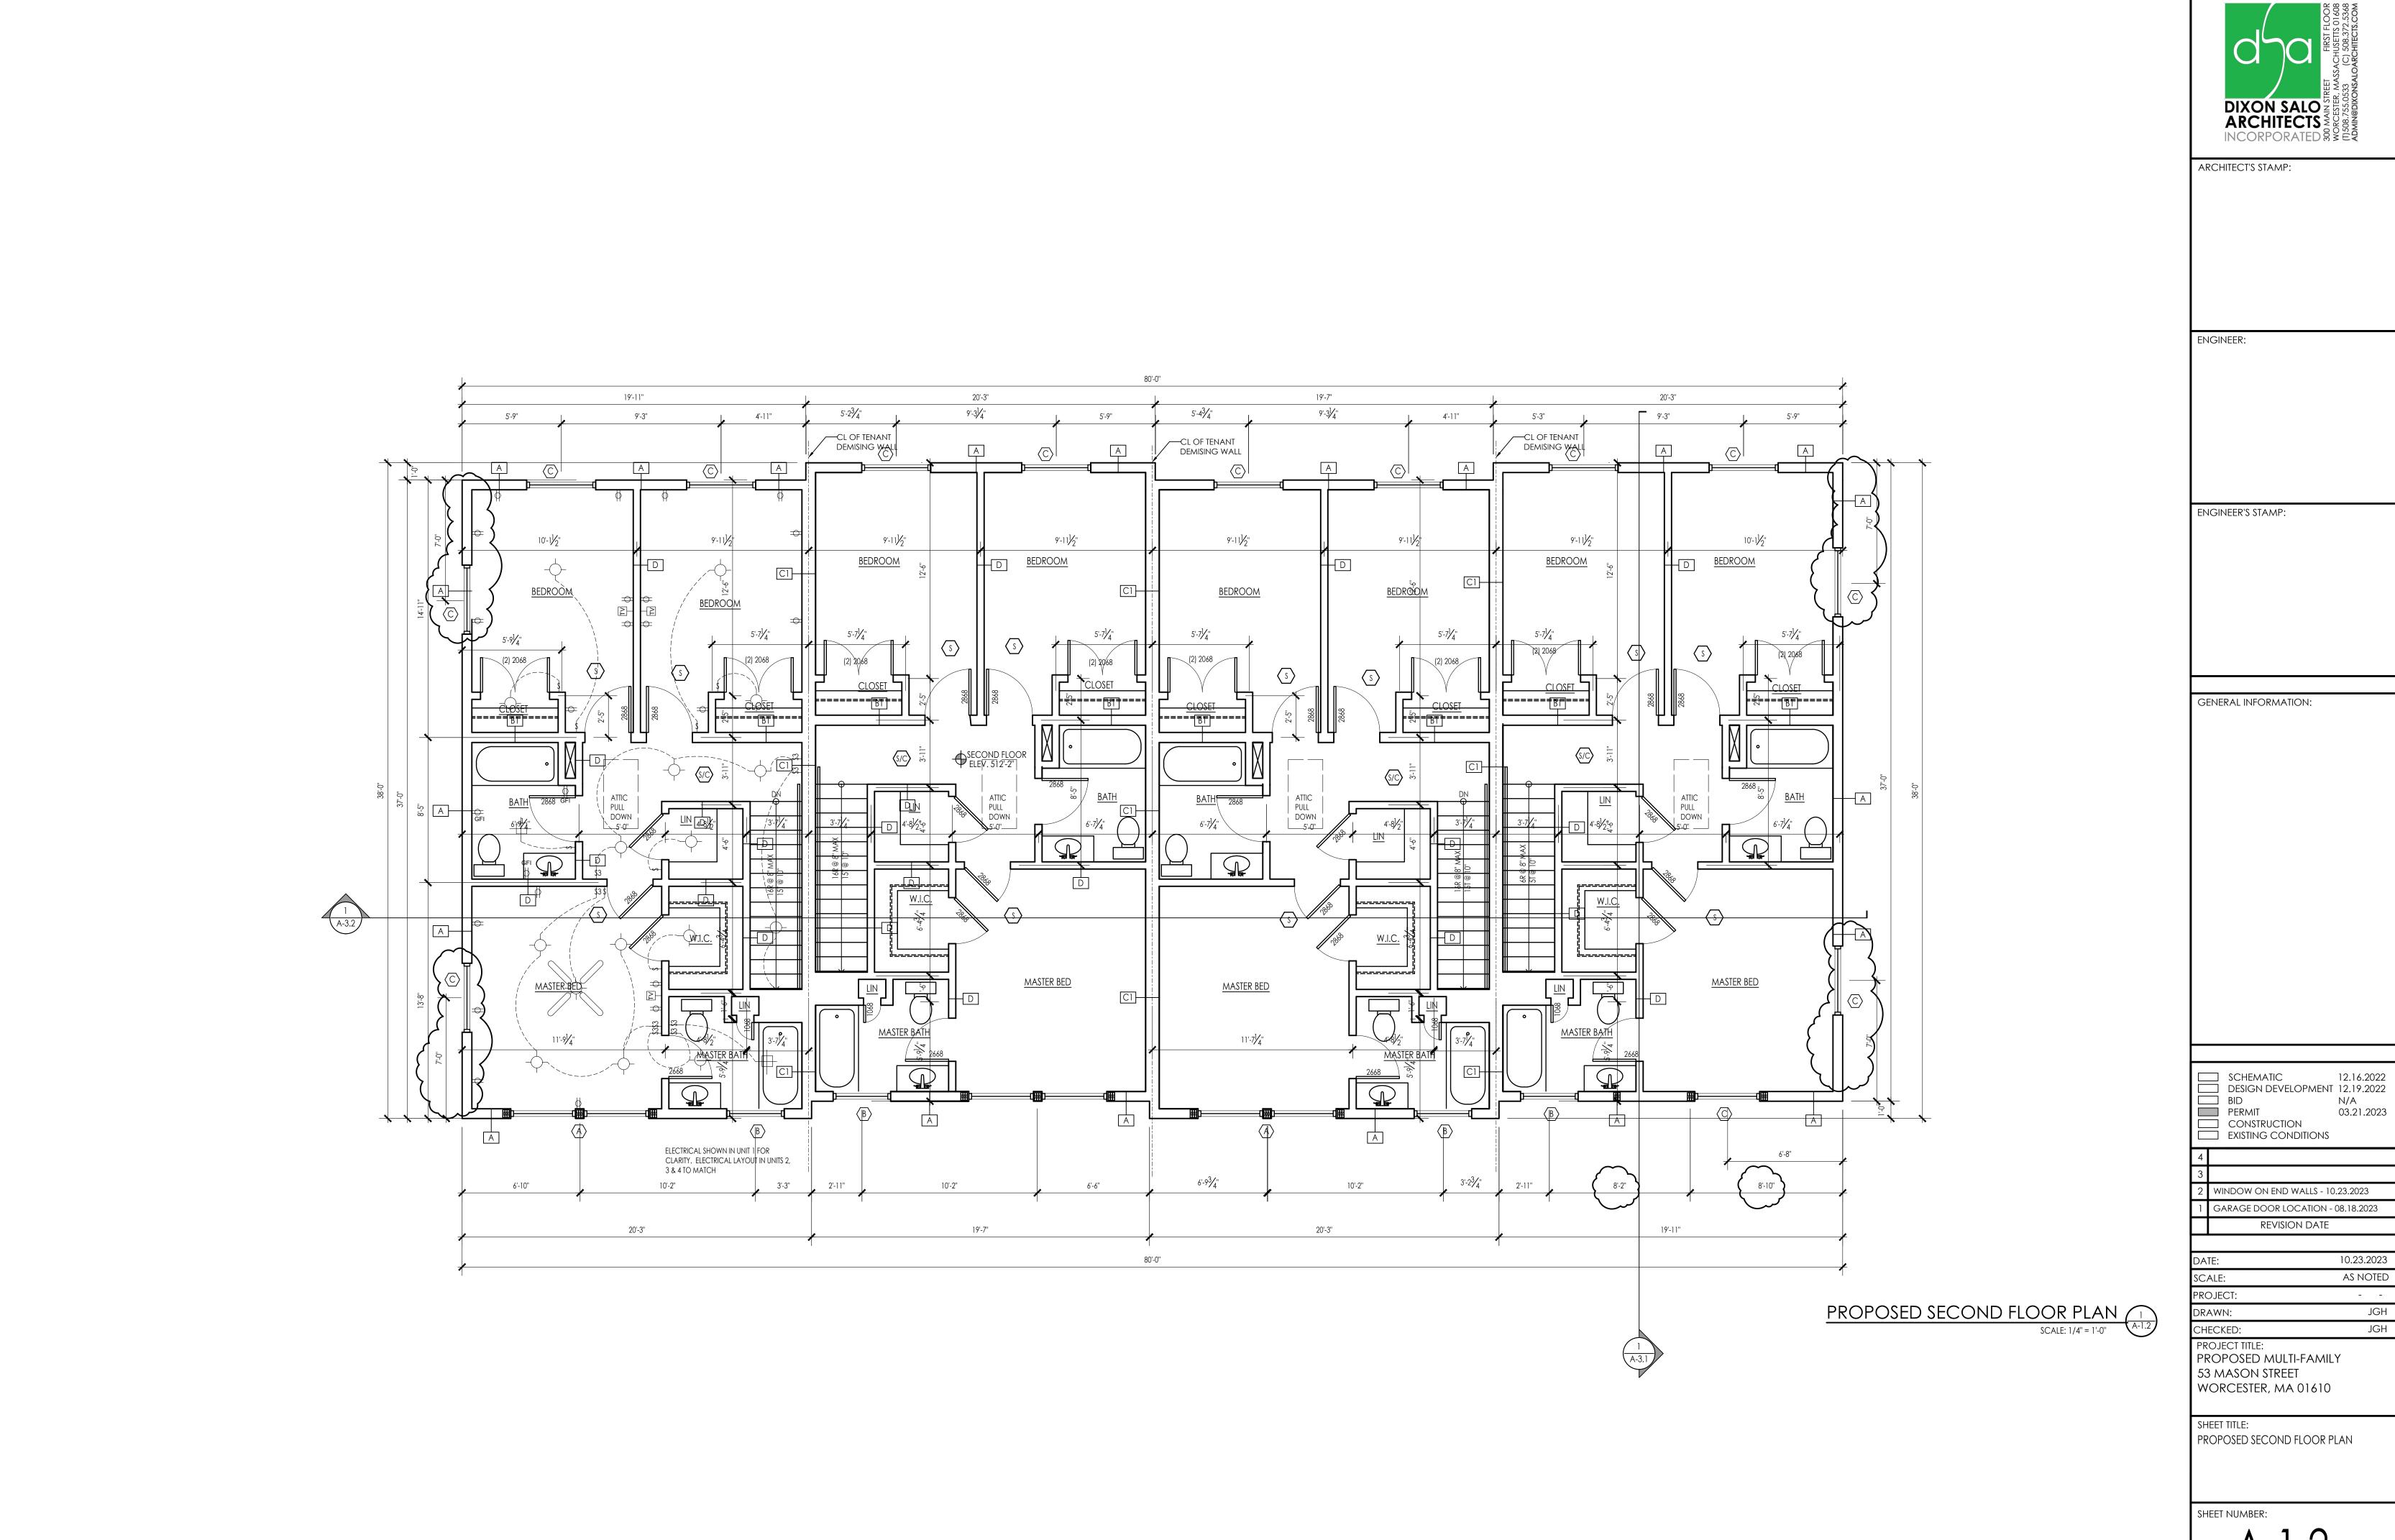


2/23/2024 7:05 PM

ARCHITECT:

SCHEMATIC 12.16.2022
DESIGN DEVELOPMENT 12.19.2022 03.21.2023

WINDOW ON END WALLS - 10.23.2023 GARAGE DOOR LOCATION - 08.18.2023

10.23.2023 AS NOTED JGH

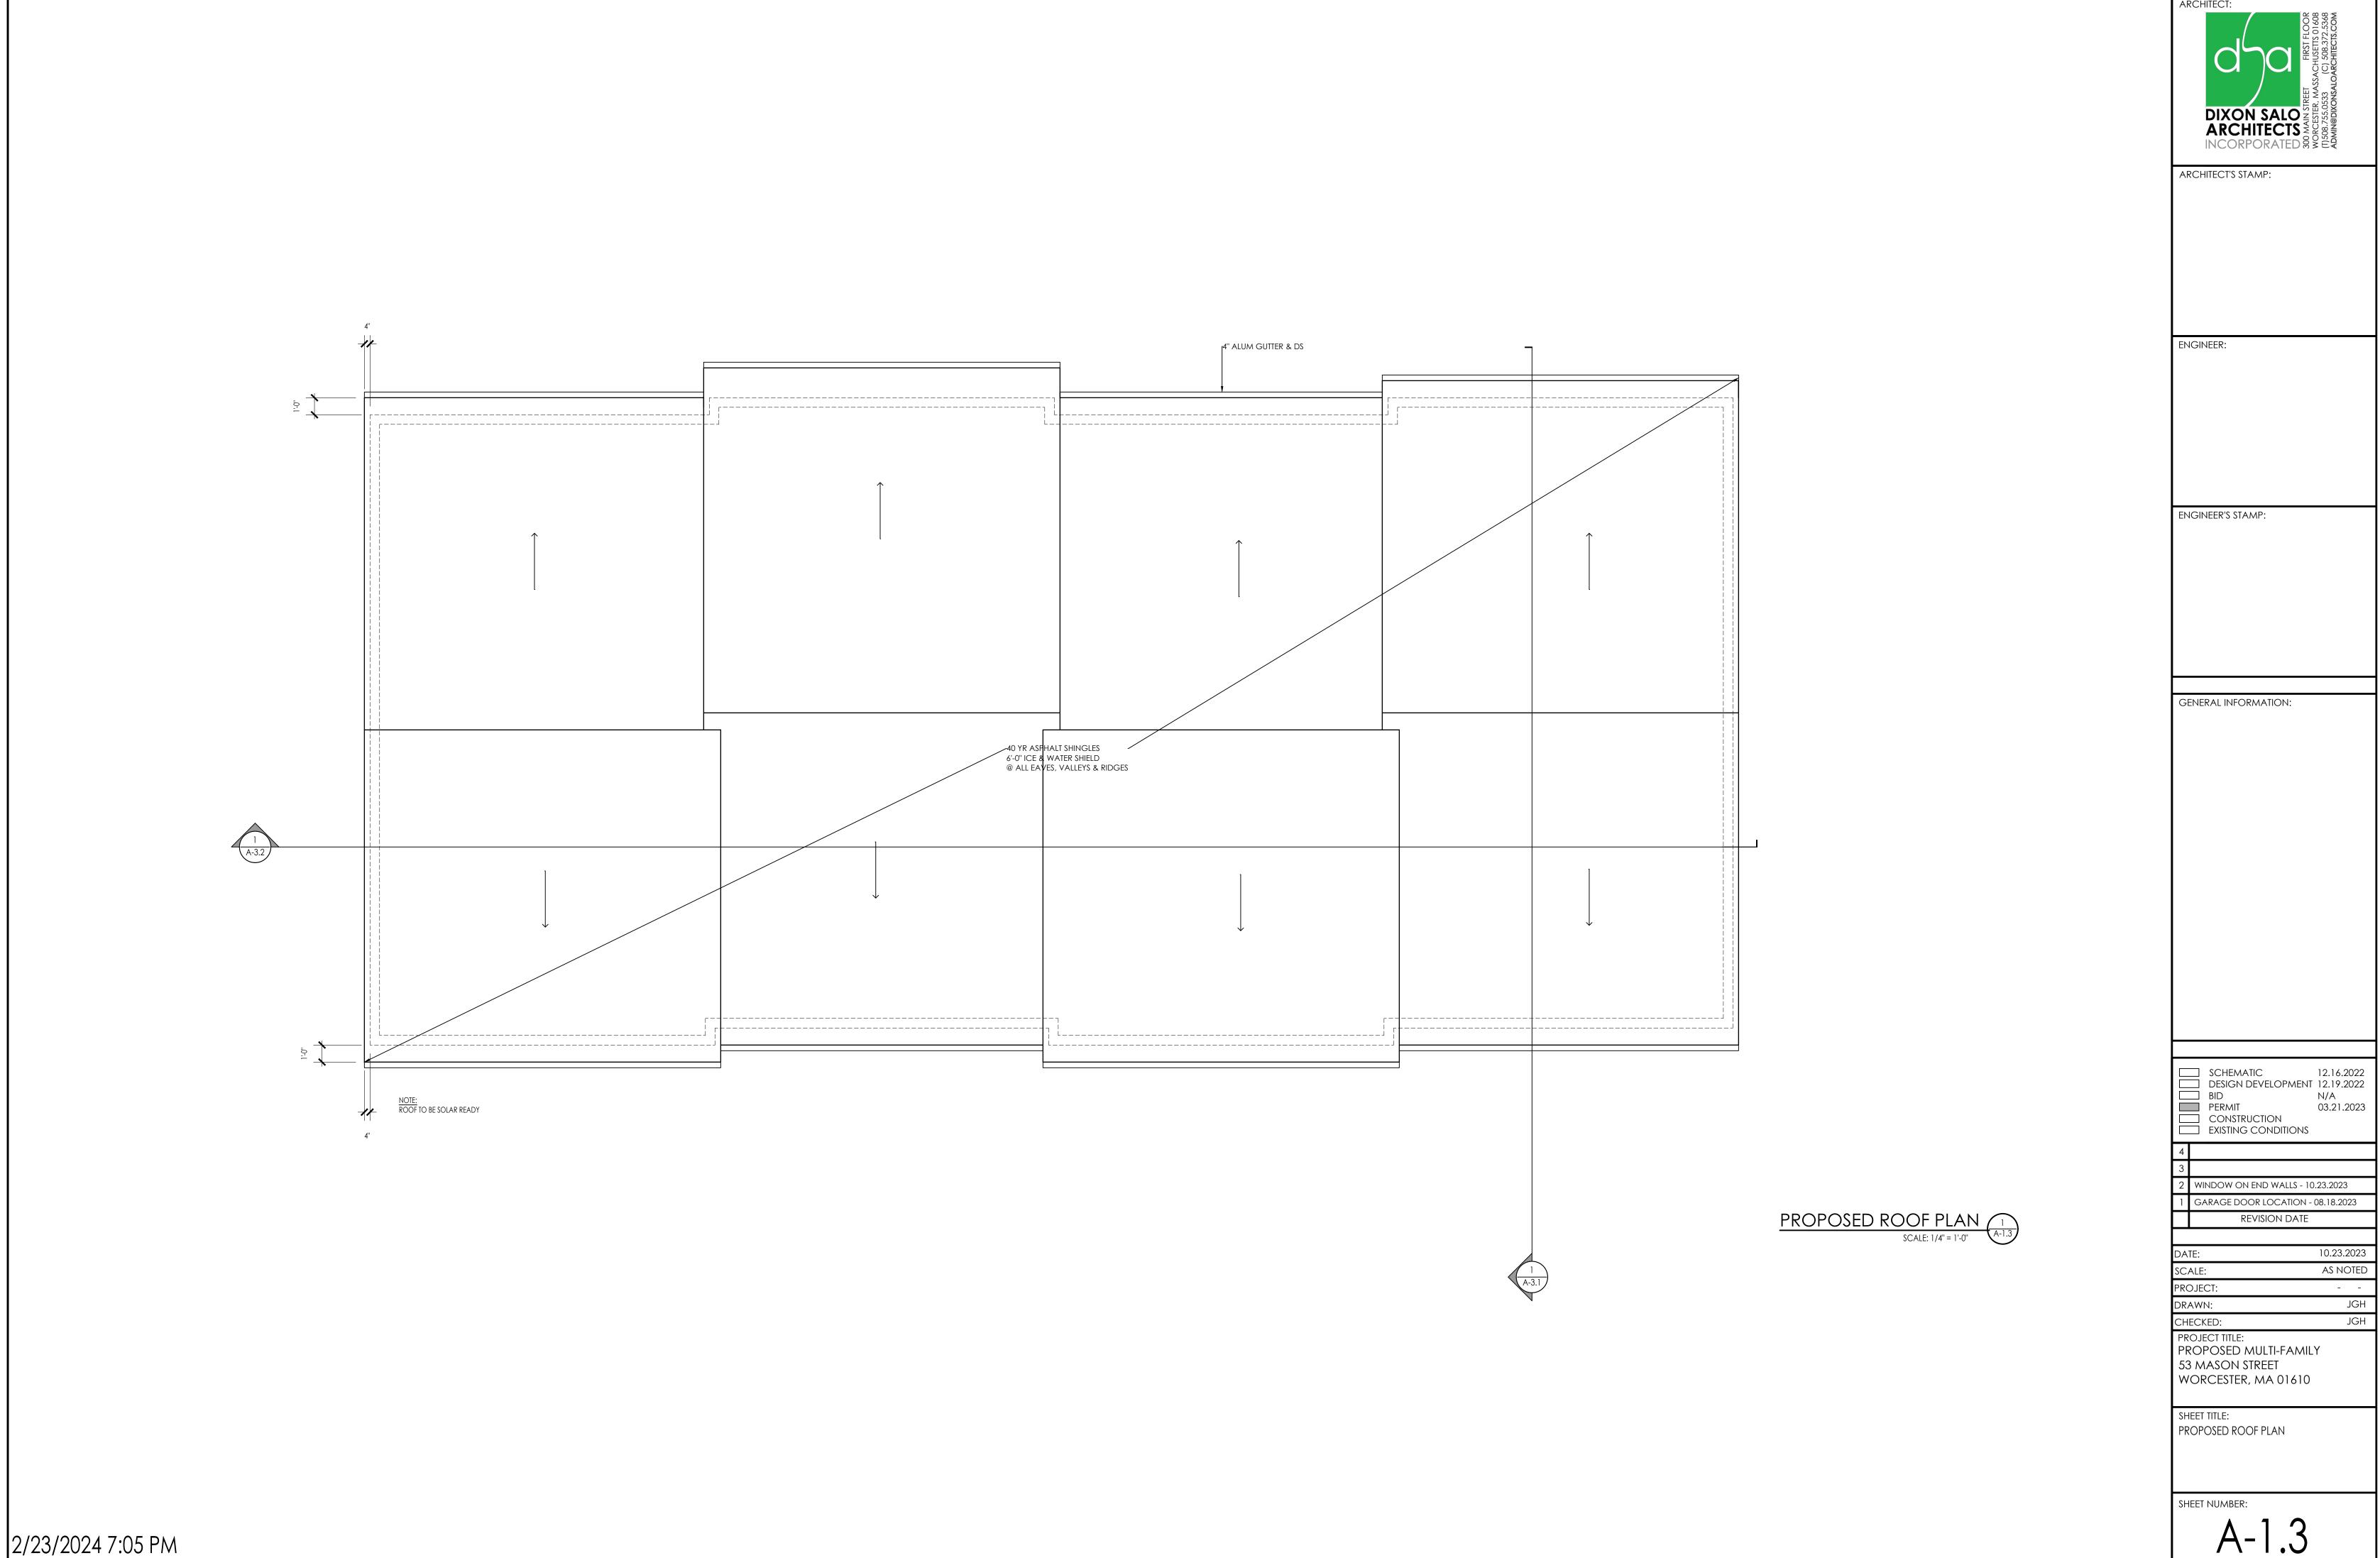



ARCHITECT: DIXON SALO
ARCHITECTS

MONCESTER

ARCHITECT'S STAMP:

ENGINEER:

ENGINEER'S STAMP:

GENERAL INFORMATION:

SCHEMATIC 12.16.2022
DESIGN DEVELOPMENT 12.19.2022
BID N/A
PERMIT 03.21.2023
CONSTRUCTION
EXISTING CONDITIONS

2 WINDOW ON END WALLS - 10.23.2023 1 GARAGE DOOR LOCATION - 08.18.2023


REVISION DATE

10.23.2023 AS NOTED DRAWN: CHECKED: JGH JGH

PROJECT TITLE:
PROPOSED MULTI-FAMILY
53 MASON STREET
WORCESTER, MA 01610

SHEET TITLE:
BUILDING ELEVATION - FRONT

SHEET NUMBER:

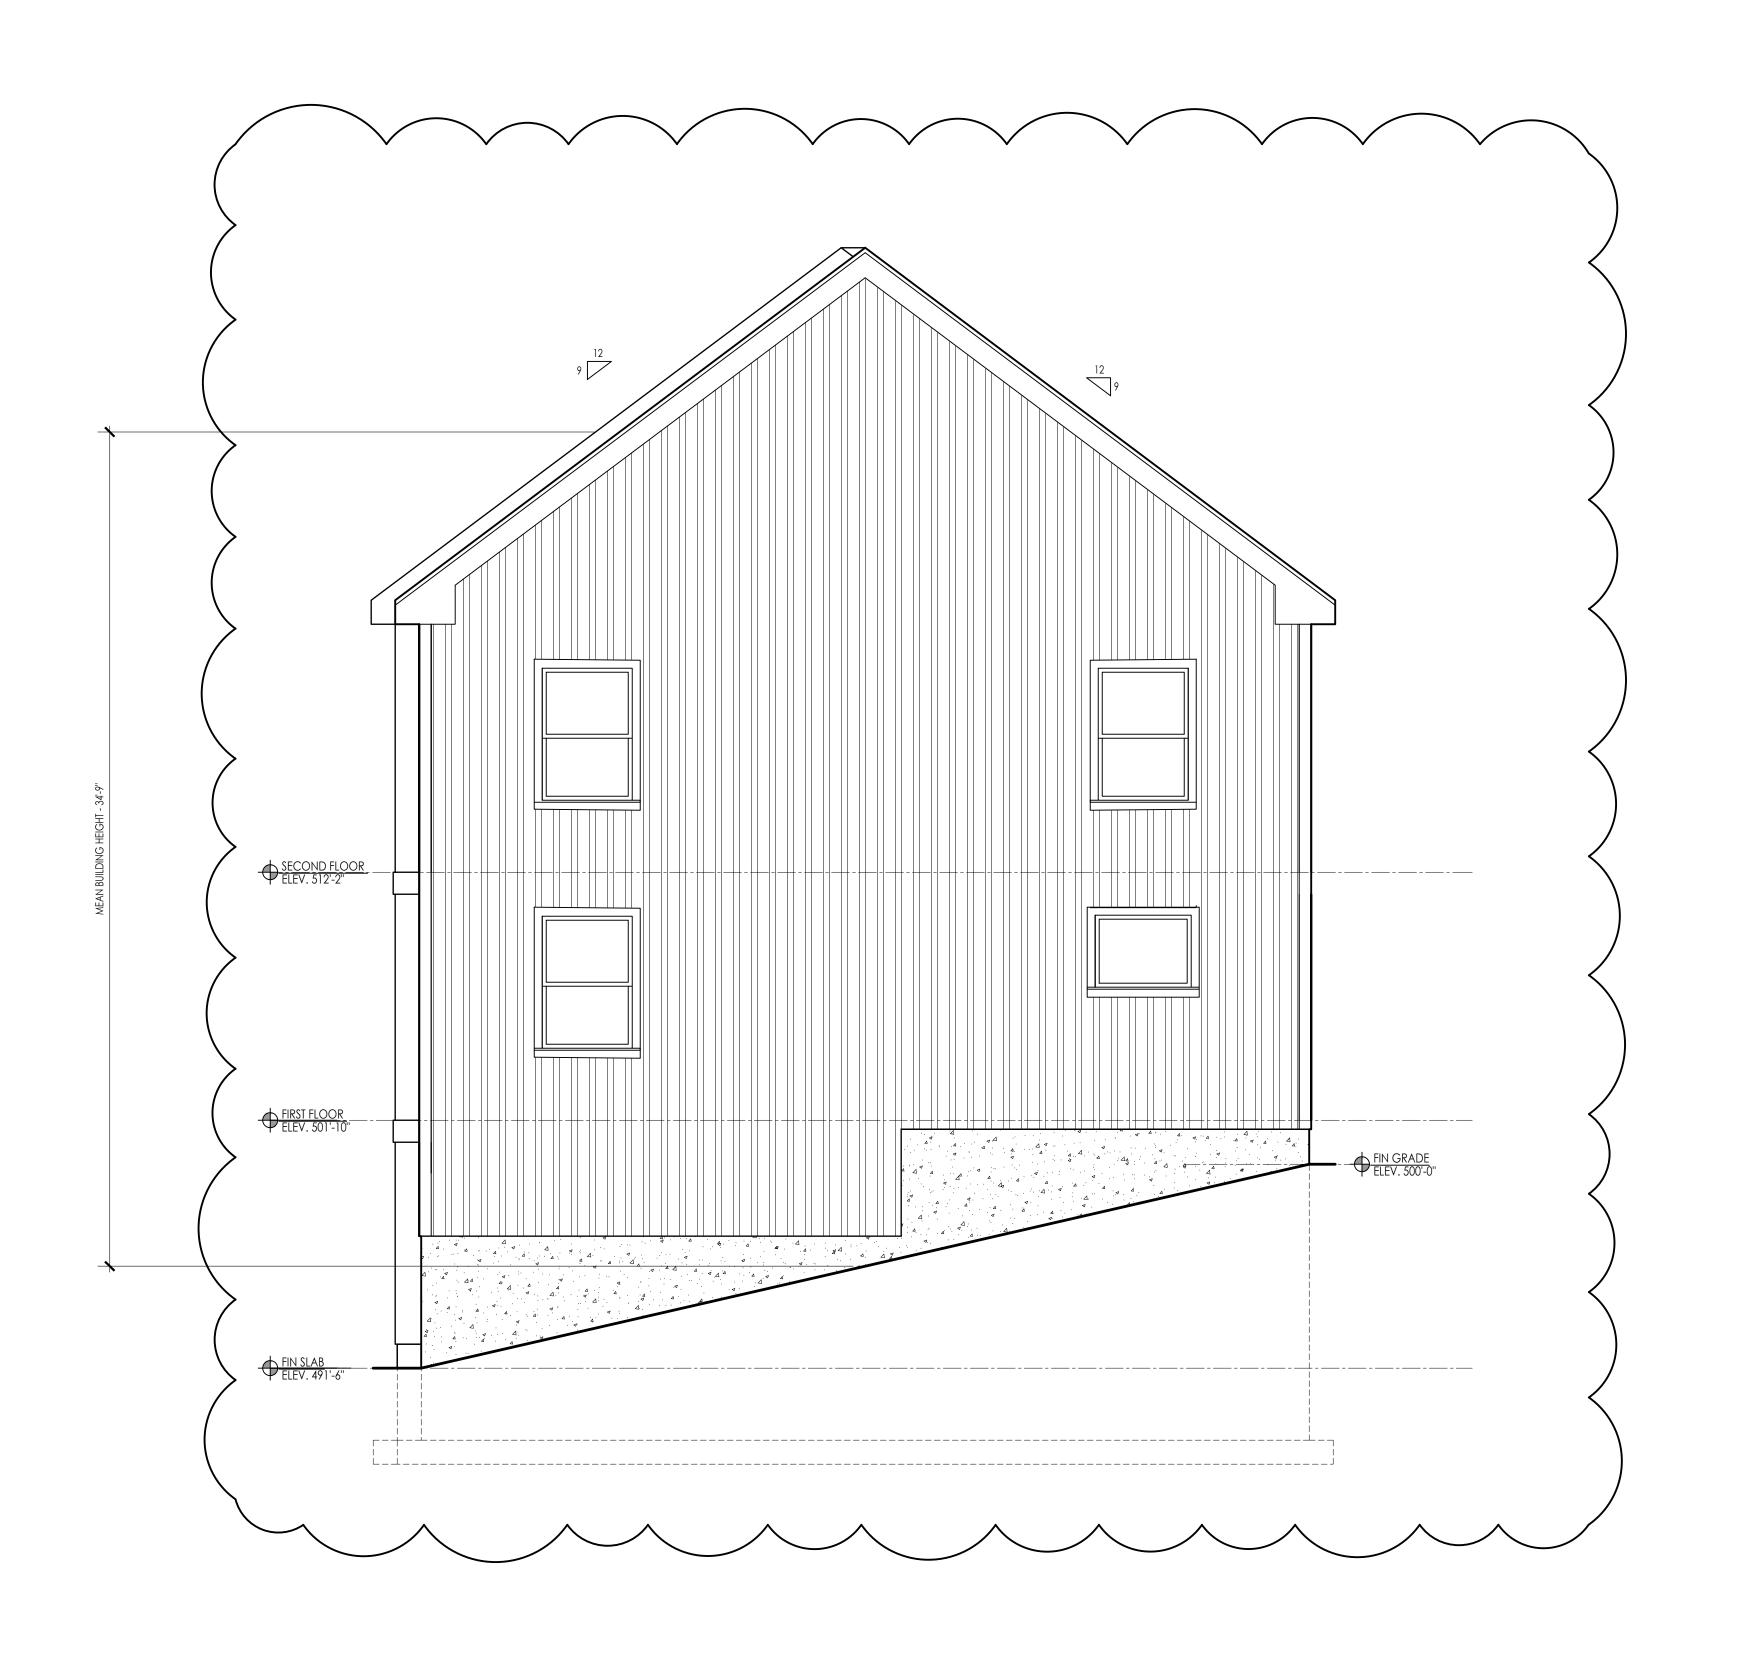



ARCHITECT'S STAMP:

ENGINEER:

ENGINEER'S STAMP:

GENERAL INFORMATION:

SCHEMATIC 12.16.2022
DESIGN DEVELOPMENT 12.19.2022
BID N/A
PERMIT 03.21.2023
CONSTRUCTION
EXISTING CONDITIONS

2 WINDOW ON END WALLS - 10.23.2023 1 GARAGE DOOR LOCATION - 08.18.2023

REVISION DATE

10.23.2023 AS NOTED DRAWN: JGH JGH

CHECKED: PROJECT TITLE:
PROPOSED MULTI-FAMILY
53 MASON STREET


WORCESTER, MA 01610

BUILDING ELEVATION - RIGHT SIDE

SHEET NUMBER:

BUILDING ELEVATION - RIGHT SIDE (A-2.2)



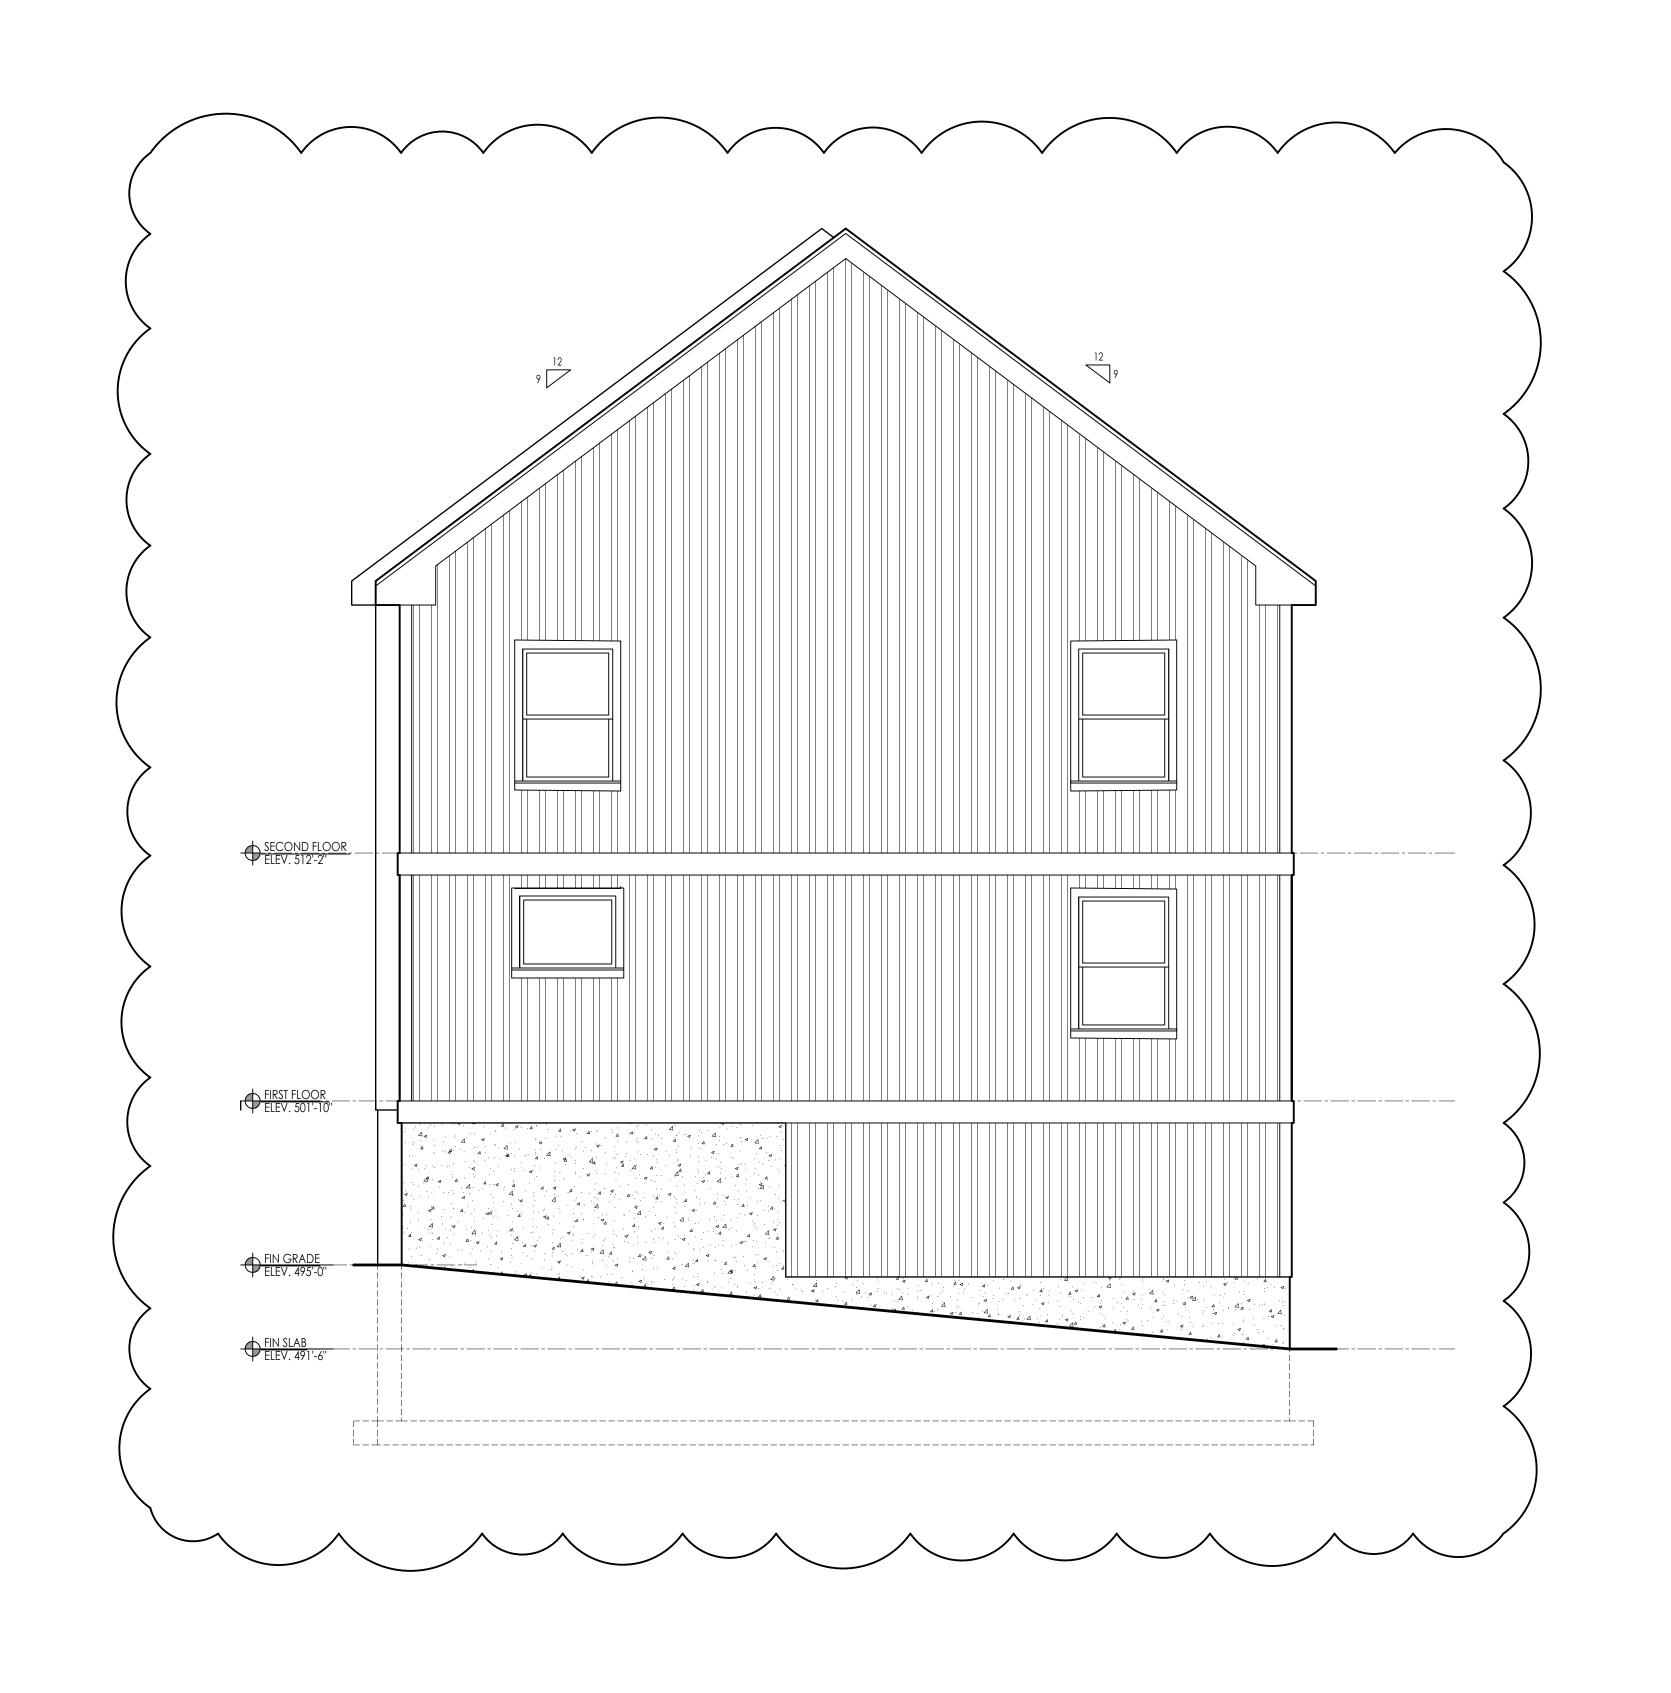



ARCHITECT'S STAMP:

ENGINEER:

ENGINEER'S STAMP:

GENERAL INFORMATION:

SCHEMATIC 12.16.2022
DESIGN DEVELOPMENT 12.19.2022
BID N/A
PERMIT 03.21.2023
CONSTRUCTION
EXISTING CONDITIONS

2 WINDOW ON END WALLS - 10.23.2023 1 GARAGE DOOR LOCATION - 08.18.2023

10.23.2023 AS NOTED

REVISION DATE

DRAWN: JGH JGH

CHECKED: PROJECT TITLE:
PROPOSED MULTI-FAMILY
53 MASON STREET

WORCESTER, MA 01610

BUILDING ELEVATION - LEFT SIDE

BUILDING ELEVATION - LEFT SIDE 1 SCALE: 1/4" = 1'-0"

SHEET NUMBER:

